SITE DEVELOPMENT PLANS

SEVEN BREW

7 WEST MAIN STREET FARMINGTON, ARKANSAS

Land and Life

CEI ENGINEERING ASSOCIATES, INC. 2600 NE 11TH ST, SUITE 300 BENTONVILLE, AR 72712 PHONE: (479) 273-9472

	REVISION	
NO.	DESCRIPTION	DATE



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C8.2 DETAIL SHEET III

1 OF 1

354 W. MAIN ST.

FARMINGTON, AR 72730

MELISSA MCCARVILLE

PHONE: (479) 267-3865

BUILDING CITY OF FARMINGTON

PHONE: (479) 267-3865

ENGINEERING CITY OF FARMINGTON

MELISSA MCCARVILLE

PHONE: (479) 267-3865

STORMWATER CITY OF FARMINGTON

FARMINGTON, AR 72730

PHONE: (479) 267-3865

FIRE DEPARTMENT CITY OF FARMINGTON

PHONE: (479) 267-3338

372 W. MAIN ST. FARMINGTON, AR 72730

BILL HELLARD

372 W. MAIN ST.

FLOYD SHELLEY

FARMINGTON, AR 72730

354 W. MAIN ST.

FARMINGTON, AR 72730

372 W. MAIN ST.

RICK BRAMALL

ASSOCIATED PLANS:

ALTA/ACSM SURVEY

ADS STORMTECH LAYOUT

MELISSAMCCARVILLE@CITYOFFARMINGTON-AR.GOV

RICHARDBRAMALL@CITYOFFARMINGTON-AR.GOV

FLOYDSHELLEY@CITYOFFARMINGTON-AR.GOV

WILLIAMHELLARD@CITYOFFARMINGTON-AR.GO\

MELISSAMCCARVILLE@CITYOFFARMINGTON-AR.GOV BLACK HILLS ENERGY

C1.0 DEMOLITION PLAN

C4.0 EROSION CONTROL PLAN

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L1.1 LANDSCAPE NOTES AND DETAILS

L2.1 IRRIGATION NOTES AND DETAILS

ARKANSAS ENVIRONMENTAL HEALTH

EMAIL: ELIZABETH.DICKINSON@ARKANSAS.GOV

EMAIL: CGRANDERSON@FAYETTEVILLE-AR.GOV

EMAIL: JEFF.LANEY@BLACKHILLSCORP.COM

4815 W. MARKHAM ST

LITTLE ROCK, AR 72205

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PHONE: (479) 444-3452

COREY GRANDERSON

101 W. TOWNSHIP ST.

CHRISTIAN D DICKEY

655 E. MILLSAP RD

139 N. MOCK ST PRAIRIE GROVE, AR 72753

SHANE BELL

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FAYETTEVILLE, AR 72703

PHONE: (479) 530-0292

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EMAIL: SBELL@PGTC.COM

TELEPHONE PRAIRIE GROVE TELEPHONE CO.

FAYETTEVILLE, AR 72703

PHONE: (479) 973-2306

EMAIL: CDDICKEY@AEP.COM

CITY OF FAYETTEVILLE UTILITIES

SEVEN BREW
7 WEST MAIN STREET
FARMINGTON, ARKANS

LICENSED PROFESSIONAL ENGINEER

PROFESSIONAL OF RECORD PROJECT MANAGER EVD BWB DESIGNER CEI PROJECT NUMBER 34338 2/10/2025 REVISION

COVER SHEET

SHEET NUMBER



- A. TOPOGRAPHIC BOUNDARY SURVEY, INCLUDING PROPERTY LINES, LEGAL DESCRIPTION, EXISTING UTILITIES, SITE TOPOGRAPHY WITH SPOT ELEVATIONS, OUTSTANDING PHYSICAL FEATURES AND EXISTING STRUCTURE LOCATIONS WAS PROVIDED BY THE FOLLOWING COMPANY. AS A CONTRACTOR TO THE SELLER/OWNER:
 - TOPOGRAPHY & BOUNDARY: GOLDEN LAND SURVEYING 4131 N.W. 122ND ST., SUITE 100 OKLAHOMA CITY, OKLAHOMA 73120 PH: (405) 849-6010

CEI ENGINEERING AND ITS ASSOCIATES WILL NOT BE HELD RESPONSIBLE FOR THE ACCURACY OF THE SURVEY OR FOR DESIGN ERRORS OR OMISSIONS RESULTING FROM SURVEY INACCURACIES.

- B. ALL PHASES OF SITE WORK FOR THIS PROJECT SHALL MEET OR EXCEED THE OWNER / DEVELOPER SITE WORK SPECIFICATIONS.
- CONTRACTOR SHALL BE RESPONSIBLE FOR THE REMOVAL OF EXISTING STRUCTURES, RELATED UTILITIES, PAVING, UNDERGROUND STORAGE TANKS AND ANY OTHER EXISTING IMPROVEMENTS AS NOTED. SEE SITE WORK SPECIFICATIONS.
- D. CONTRACTOR IS TO REMOVE AND DISPOSE OF ALL DEBRIS, RUBBISH AND OTHER MATERIALS RESULTING FROM PREVIOUS AND CURRENT DEMOLITION OPERATIONS. DISPOSAL WILL BE IN ACCORDANCE WITH ALL LOCAL, STATE AND/OR FEDERAL REGULATIONS GOVERNING SUCH
- THE GENERAL CONTRACTOR WILL BE HELD SOLELY RESPONSIBLE FOR AND SHALL TAKE ALL PRECAUTIONS NECESSARY TO AVOID PROPERTY DAMAGE TO ADJACENT PROPERTIES DURING THE CONSTRUCTION PHASES OF THIS PROJECT.
- THE DESIGNS REPRESENTED IN THESE PLANS ARE IN ACCORDANCE WITH ESTABLISHED PRACTICES OF CIVIL ENGINEERING FOR THE DESIGN FUNCTIONS AND USES INTENDED BY THE OWNER AT THIS TIME. HOWEVER, NEITHER THE ENGINEER NOR ITS PERSONNEL CAN OR DO WARRANT THESE DESIGNS OR PLANS AS CONSTRUCTED EXCEPT IN THE SPECIFIC CASES WHERE THE ENGINEER INSPECTS AND

CONTROLS THE PHYSICAL CONSTRUCTION ON A CONTEMPORANEOUS BASIS AT THE SITE.

- N ACCORDANCE WITH GENERALLY ACCEPTED CONSTRUCTION PRACTICES, THE CONTRACTOR SHALL BE SOLELY AND COMPLETELY RESPONSIBLE FOR CONDITIONS OF THE JOB SITE, INCLUDING SAFETY OF ALL PERSONS AND PROPERTY DURING PERFORMANCE OF THE WORK, THIS REQUIREMENT WILL APPLY CONTINUOUSLY AND NOT BE LIMITED TO NORMAL WORKING HOURS. ANY CONSTRUCTION OBSERVATION BY THE ENGINEER OF THE CONTRACTOR'S PERFORMANCE IS NOT INTENDED TO INCLUDE REVIEW OF THE ADEQUACY OF THE CONTRACTOR'S SAFETY MEASURES, IN. ON OR NEAR
- ALL CONSTRUCTION IN STATE HIGHWAY DEPARTMENT RIGHT-OF-WAY SHALL BE COORDINATED WITH THE HIGHWAY DEPARTMENT RESIDENT ENGINEER.
- RESIDENT ENGINEERING SERVICES WHEN REQUESTED BY THE OWNER, RESIDENT ENGINEERING SERVICES SHALL BE PROVIDED BY THE ENGINEERS (ON A TIME AND FREQUENCY BASIS) ACCEPTABLE TO THE CITY ENGINEER FOR IMPROVEMENTS TO PUBLIC WATER MAINS, PUBLIC SEWER, AND CITY STREETS. AT THE COMPLETION OF CONSTRUCTION, THE ENGINEER SHALL CERTIFY THE CONSTRUCTION TO BE IN COMPLIANCE WITH THE PLANS AND SPECIFICATIONS. THIS WORK WILL BE AT THE OWNER/DEVELOPER'S DIRECT EXPENSE AND SHALL BE COORDINATED WITH CEI ENGINEERING ASSOCIATES, INC. IT WILL BE THE CONTRACTOR'S RESPONSIBILITY TO NOTIFY THE RESIDENT ENGINEER OF ANY PRECONSTRUCTION / CONSTRUCTION CONFERENCES AND ANY PUBLIC CONSTRUCTION 24 HOURS PRIOR TO SAID ACTION.

NOTICE TO BIDDERS:

ALL QUESTIONS REGARDING THE PREPARATION OF THE GENERAL CONTRACTOR'S BID SHALL BE DIRECTED TO THE OWNER'S FIELD CONSTRUCTION MANAGER:

WADE HARDEN

CTAR, INC. PHONE: (972) 832-2048

SUBCONTRACTORS MUST DIRECT THEIR QUESTIONS THROUGH THE GENERAL CONTRACTOR. THE CONSULTING ARCHITECT AND/OR THE CONSULTING ENGINEER SHALL NOT BE CONTACTED DIRECTLY WITHOUT PRIOR AUTHORIZATION FROM THE OWNER/DEVELOPER.

FLOOD CERTIFICATION:

BY SCALED MAP LOCATION AND GRAPHICAL PLOTTING ONLY. THIS PROPERTY IS LOCATED IN ZONE "X" UNSHADED WHICH ARE AREAS DETERMINED TO BE OUTSIDE THE 0.2% ANNUAL CHANCE FLOODPLAIN DETERMINED BY THE NATIONAL FLOOD INSURANCE PROGRAM, FLOOD INSURANCE RATE MAP FOR WASHINGTON COUNTY, ARKANSAS MAP NUMBER: 05143C0215G MAP REVISED: JANUARY 1ST, 2024


APPROVED

DATE

CITY OF FARMINGTON, ARKANSAS ARKANSAS DEPARTMENT OF TRANSPORTATION



Know what's **below. Call** before you dig.

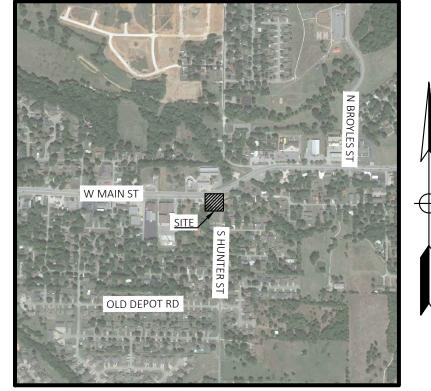

VICINITY MAP

CEI CONTACT:

ERIN DUDLEY PROJECT MANAGER 2600 NE 11TH ST., SUITE 300 BENTONVILLE, AR 72712 EDUDLEY@CEIENG.COM PHONE: (479) 321-0035

OWNER:

CTAR, INC. WADE HARDEN 2 NORTH COLLEGE AVENUE FAYETTEVILE, AR 72701 SHANE.CORNYN@7BREW.COM

PHONE: (972) 832-2048

ARCHITECT:


ARKIFEX STUDIOS MICHAEL HAMPTON 221 SOUTH AVENUE SPRINGFIELD, MO 65806 MICHAEL@ARKIFEXSTUDIOS.COM

PHONE: (417) 773-1065



Solutions for Land and Life

CIVIL ENGINEERING • LANDSCAPE ARCHITECTURE • LAND SURVEYING • PLANNING BENTONVILLE | DALLAS | FRESNO | HOUSTON | JACKSONVILLE | MINNEAPOLIS | PHILADELPHIA | PHOENIX

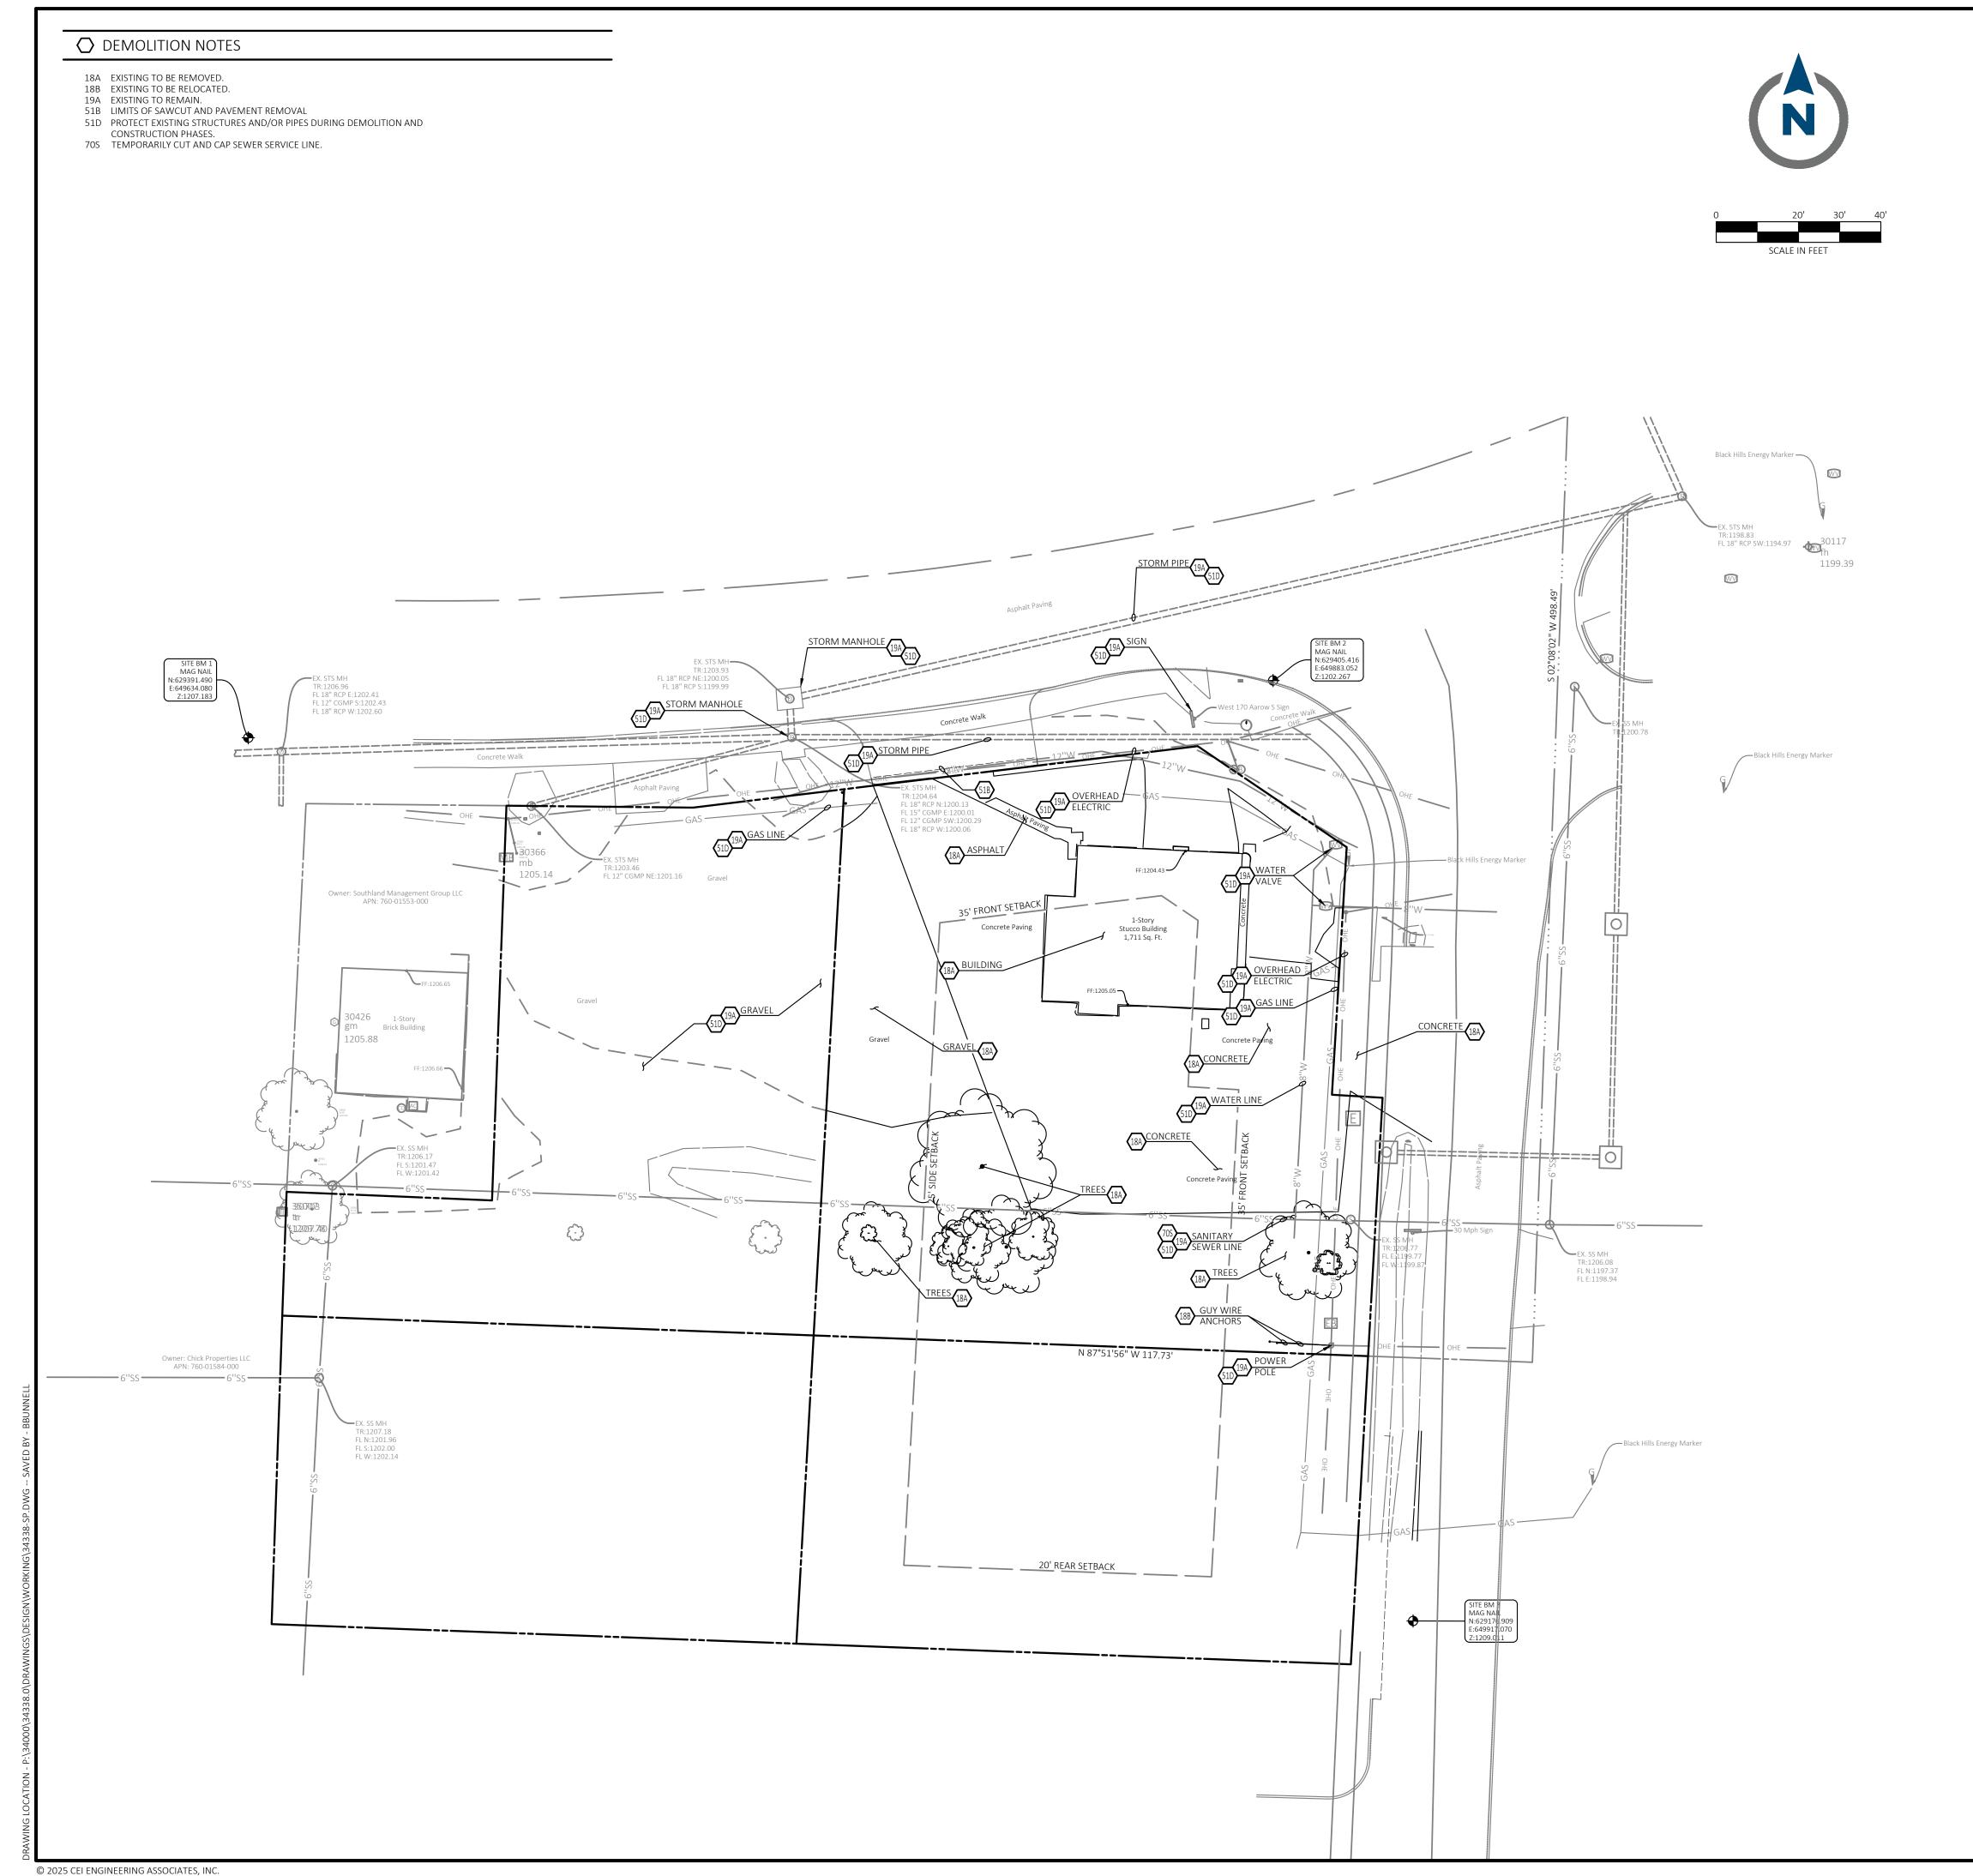



Know what's **below**. **Call** before you dig.

SITE BENCHMARK 1: MAG NAIL N: 629391.490 E: 649634.080 Z: 1207.183 SITE BENCHMARK 2: MAG NAIL N: 629405.416 E: 649883.052 Z: 1202.267 SITE BENCHMARK 3: N: 629176.909 E: 649917.070 Z: 1209.011

EXISTING LEGEND



VICINITY MAP

NOT TO SCALE NOT TO SCALE

TRAFFIC SIGNAL BOX TRAFFIC SIGNAL PULL BOX PEDESTRIAN CROSSING SIGNAL

KEY PAD 🔘 COLUMN

SECTION CORNER QUARTER CORNER SET IRON PIN W/CAP SET MAG NAIL W/WASHER

FOUND MONUMENT

RIGHT OF WAY MARKER

OIL PIPELINE MARKER



LEGEND


\varnothing	POWER POLE	©	GAS METER
\$	LIGHT POLE	©V	GAS VALVE
Ċ	GUY ANCHOR	Ğ	GAS MARKER
E	ELECTRIC METER	0	OIL PIPELINE MAF
EB	ELECTRIC BOX	MB	MAIL BOX
TRAN	ELEC. TRANSFORMER	الاستان الاستان	SIGN
(E)	ELEC. MANHOLE		FLAG POLE
EP	ELEC. PEDESTAL	-	FIRE HYDRANT
EPB	ELEC. PULL BOX	$\langle \! \! \! \! \! \! \! \! \! \! \! \! \! \! \! \! \! \! \!$	WATER MANHOLI
	SPOT LIGHT		WATER VALVE
S	SANITARY SEWER MANHOLE	\odot	WATER METER
(0)	SANITARY SEWER CLEANOUT	•	DOWN SPOUT
	STORM SEWER MANHOLE	AC	AIR CONDITIONER
T	TELEPHONE RISER	-	TRAFFIC SIGNAL
\bigcirc	TELEPHONE MANHOLE	TSB	TRAFFIC SIGNAL B
Ţ	TELEPHONE MARKER	TRPB	TRAFFIC SIGNAL P
TPB	TELEPHONE PULL BOX		PEDESTRIAN CROS
F	FIBER OPTIC MARKER	GT	GREASE TRAP
FOB	FIBER OPTIC PULL BOX		KEY PAD 🔘
CT	CABLE TV PEDESTAL		SECTION CORNER
C	CABLE MARKER	▶0~	QUARTER CORNE
СРВ	CABLE TV PULL BOX	0	SET IRON PIN W/0
(SP)	IRRIGATION CONTROL VALVE	0	SET MAG NAIL W,
©	SPRINKLER HEAD	•	FOUND MONUME
(B)	BOLLARD (VENT PIPE	RW	RIGHT OF WAY M
₩	FIRE DEPARTMENT CONNECT	(H)	YARD HYDRANT/S
	PROPANE TANK	•	BENCHMARK
		SATELLITE D	ISH color
	WATER LINE	•	- CHAIN
 G	——— GAS LINE		WOOE MASO
SS	SANITARY SEWER LINE	Δ	IRON F
Т	——— TELEPHONE LINE	— FO — FO —	— FO — FIBER
E	ELECTRIC LINE		PROPE

YARD HYDRANT/SPICKET BENCHMARK CHAIN LINK FENCE ----- MASONRY FENCE ------ IRON FENCE — FO — FIBER OPTIC LINE OHE OVERHEAD POWERLINE — — EASEMENT LINE

_____ x ____ BARBED WIRE FENCE _____ SECTION LINE S.I.P.-SET IRON PIN I.P.-IRON PIN CGMP-CORRUGATED METAL PIPE B/L/L-BUILDING LIMIT LINE F.I.P.-FOUND IRON PIN H/C-HANDICAP RCP-REINFORCED CONCRETE PIPE U/E-UTILITY EASEMENT NOTE: ALL MONUMENTS SET ARE CAPPED 1/2" IRON PINS OR MAG NAILS WITH WASHERS BOTH BEING STAMPED "DEE LS 1835"

GENERAL DEMOLITION NOTES

- A. THE SITE WORK FOR THIS PROJECT SHALL MEET OR EXCEED THE "7BREW STANDARD SITE WORK SPECIFICATIONS".
- B. CONTRACTOR SHALL BE RESPONSIBLE FOR REMOVAL OF THE EXISTING STRUCTURES, RELATED UTILITIES, PAVING, UNDERGROUND STORAGE TANKS AND ANY OTHER EXISTING IMPROVEMENTS AS NOTED. SEE SITE WORK SPECIFICATIONS.
- C. CONTRACTOR IS TO REMOVE AND DISPOSE OF ALL DEBRIS, RUBBISH AND OTHER MATERIALS RESULTING FROM PREVIOUS AND CURRENT DEMOLITION OPERATIONS. DISPOSAL WILL BE IN ACCORDANCE WITH ALL LOCAL, STATE AND/OR FEDERAL REGULATIONS GOVERNING SUCH OPERATIONS.
- D. THE GENERAL CONTRACTOR SHALL TAKE ALL PRECAUTIONS NECESSARY TO AVOID PROPERTY DAMAGE TO ADJACENT PROPERTIES DURING THE CONSTRUCTION PHASES OF THIS PROJECT. THE CONTRACTOR WILL BE HELD SOLELY RESPONSIBLE FOR ANY DAMAGES TO THE ADJACENT PROPERTIES OCCURRING DURING THE CONSTRUCTION PHASES OF THIS PROJECT.
- ENGINEER'S NOTICE TO CONTRACTOR THE CONTRACTOR IS SPECIFICALLY CAUTIONED THAT THE LOCATION AND/OR ELEVATION OF EXISTING UTILITIES AS SHOWN ON THESE PLANS IS BASED ON RECORDS OF THE VARIOUS UTILITY COMPANIES, AND WHERE POSSIBLE, MEASUREMENTS TAKEN IN THE FIELD. THE INFORMATION IS NOT TO BE RELIED ON AS BEING EXACT OR COMPLETE. THE CONTRACTOR MUST CALL THE APPROPRIATE UTILITY COMPANY AT LEAST 48 HOURS BEFORE ANY EXCAVATION TO REQUEST EXACT FIELD LOCATION OF UTILITIES. IT SHALL BE THE RESPONSIBILITY OF THE CONTRACTOR TO RELOCATE ALL EXISTING UTILITIES WHICH CONFLICT WITH THE PROPOSED IMPROVEMENTS SHOWN ON THE PLANS.
- F. PRIOR TO ANY CONSTRUCTION IN RIGHT-OF-WAY, CONTRACTOR SHALL INSTALL TRAFFIC CONTROL IN ACCORDANCE WITH MUTCD.
- G. ANY WORK TO TAKE PLACE OFF-SITE SHALL BE COORDINATED WITH THE APPROPRIATE PROPERTY OWNER.

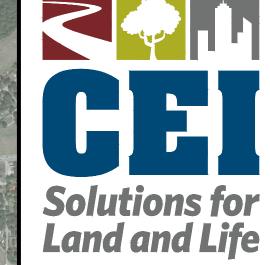

CEI ENGINEERING ASSOCIATES, INC. 2600 NE 11TH ST, SUITE 300 BENTONVILLE, AR 72712 PHONE: (479) 273-9472 FAX: (479) 273-0844

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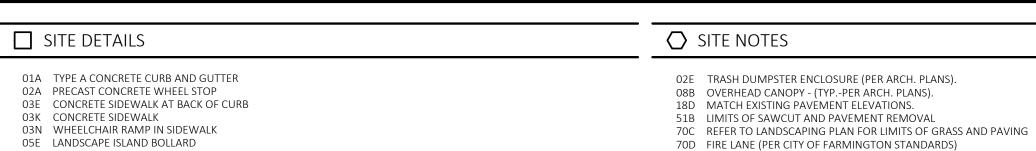


SEVEN | 7 WEST MA FARMINGTO



PROFESSIONAL OF RECORD	KAP
PROJECT MANAGER	EVD
DESIGNER	BWB
CEI PROJECT NUMBER	34338
DATE	2/10/2025
REVISION	REV-1

DEMOLITION PLAN







Know what's below. Call before you dig.

SITE BENCHMARK SITE BENCHMARK 1: MAG NAIL N: 629391.490 E: 649634.080 Z: 1207.183 SITE BENCHMARK 2: MAG NAIL N: 629405.416 E: 649883.052 Z: 1202.267 SITE BENCHMARK 3: N: 629176.909 E: 649917.070 Z: 1209.011



VICINITY MAP

EXISTING LEGEND Ø POWER POLE LIGHT POLE GUY ANCHOR E ELECTRIC METER EB ELECTRIC BOX TRAN ELEC. TRANSFORMER (E) ELEC. MANHOLE EP ELEC. PEDESTAL EPB ELEC. PULL BOX SPOT LIGHT S SANITARY SEWER MANHOLE © SANITARY SEWER CLEANOUT STORM SEWER MANHOLE T TELEPHONE RISER TELEPHONE MANHOLE

TELEPHONE MARKER TPB TELEPHONE PULL BOX FIBER OPTIC MARKER FOB FIBER OPTIC PULL BOX CT CABLE TV PEDESTAL CABLE MARKER

⑤ IRRIGATION CONTROL VALVE SPRINKLER HEAD B BOLLARD ⊕ VENT PIPE FIRE DEPARTMENT CONNECT

PROPANE TANK — w — WATER LINE GAS LINE TELEPHONE LINE ELECTRIC LINE OHE — OVERHEAD POWERLINE — — EASEMENT LINE

_____ x _____ BARBED WIRE FENCE _____ SECTION LINE WITH WASHERS BOTH BEING STAMPED "DEE LS 1835"

PROPOSED LEGEND

PROPERTY LINE/RIGHT OF WAY LINE ────── WOOD FENCE CONCRETE CURB AND GUTTER. SEE 01A DETAIL **CURB INLET GRATE INLET** BUILDING CONTROL POINT

- A. ALL DIMENSIONS SHOWN ARE TO THE FACE OF CURB UNLESS OTHERWISE NOTED.
- B. ALL CURB RETURN RADII SHALL BE 3', AS SHOWN TYPICAL ON THIS PLAN, UNLESS OTHERWISE NOTED.
- C. UNLESS OTHERWISE SHOWN, CALLED OUT OR SPECIFIED HEREON OR WITHIN THE SPECIFICATIONS: ALL CURB AND GUTTER ADJACENT TO ASPHALT PAVING SHALL BE INSTALLED PER DETAIL 01A. PAVEMENT SHALL BE INSTALLED IN ACCORDANCE WITH SHEET C7.0 - PAVING PLAN OVER THE ENTIRE PARKING LOT AREA AND ALL APPROACH DRIVES. ALL PARKING LOT STRIPING INCLUDING ACCESSIBLE AND VAN ACCESSIBLE SPACES SHALL BE PAINTED PER DETAIL: 09A.
- F. PRIOR TO ANY CONSTRUCTION IN RIGHT-OF-WAY, CONTRACTOR SHALL INSTALL TRAFFIC CONTROL IN ACCORDANCE

LEGEND

G GAS METER GV GAS VALVE GAS MARKER OIL PIPELINE MARKER MB MAIL BOX **≗** SIGN FLAG POLE FIRE HYDRANT WATER MANHOLE WV WATER VALVE

> DOWN SPOUT AC AIR CONDITIONER

TRAFFIC SIGNAL TSB TRAFFIC SIGNAL BOX TRAFFIC SIGNAL PULL BOX PEDESTRIAN CROSSING SIGNAL GT GREASE TRAP KEY PAD © COLUMN

SECTION CORNER QUARTER CORNER SET IRON PIN W/CAP SET MAG NAIL W/WASHER

FOUND MONUMENT /RW\ RIGHT OF WAY MARKER (YH) YARD HYDRANT/SPICKET

⊕ BENCHMARK SATELLITE DISH // WOOD PANEL FENCE ——— △—— IRON FENCE — FO — FO — FIBER OPTIC LINE PROPERTY LINE

S.I.P.-SET IRON PIN I.P.-IRON PIN CGMP-CORRUGATED METAL PIPE B/L/L-BUILDING LIMIT LINE F.I.P.-FOUND IRON PIN H/C-HANDICAP RCP-REINFORCED CONCRETE PIPE U/E-UTILITY EASEMENT NOTE: ALL MONUMENTS SET ARE CAPPED 1/2" IRON PINS OR MAG NAILS

PROPOSED PARKING SPACES LIMITS OF SIDEWALKS AND CONCRETE APRONS (PER ARCHITECTURAL PLANS)

GENERAL SITE NOTES

- D. ALL PARKING LOT SIGN BASE SUPPORTS SHALL BE INSTALLED PER DETAIL 12F.
- E. ALL ACCESSIBLE PARKING STALLS SHALL HAVE SIGNAGE INSTALLED PER DETAIL 09S.
- WITH MUTCD.

Land and Life

CEI ENGINEERING ASSOCIATES, INC.

2600 NE 11TH ST, SUITE 300

BENTONVILLE, AR 72712

PHONE: (479) 273-9472

FAX: (479) 273-0844

REVISION


NO. DESCRIPTION

SEVEN BRE 7 WEST MAIN ST FARMINGTON, A LICENSED PROFESSIONAL ENGINEER

PROFESSIONAL OF RECORD	KA
PROJECT MANAGER	EV
DESIGNER	BW
CEI PROJECT NUMBER	3433
DATE	2/10/202
REVISION	REV-

SITE PLAN

SHEET NUMBER

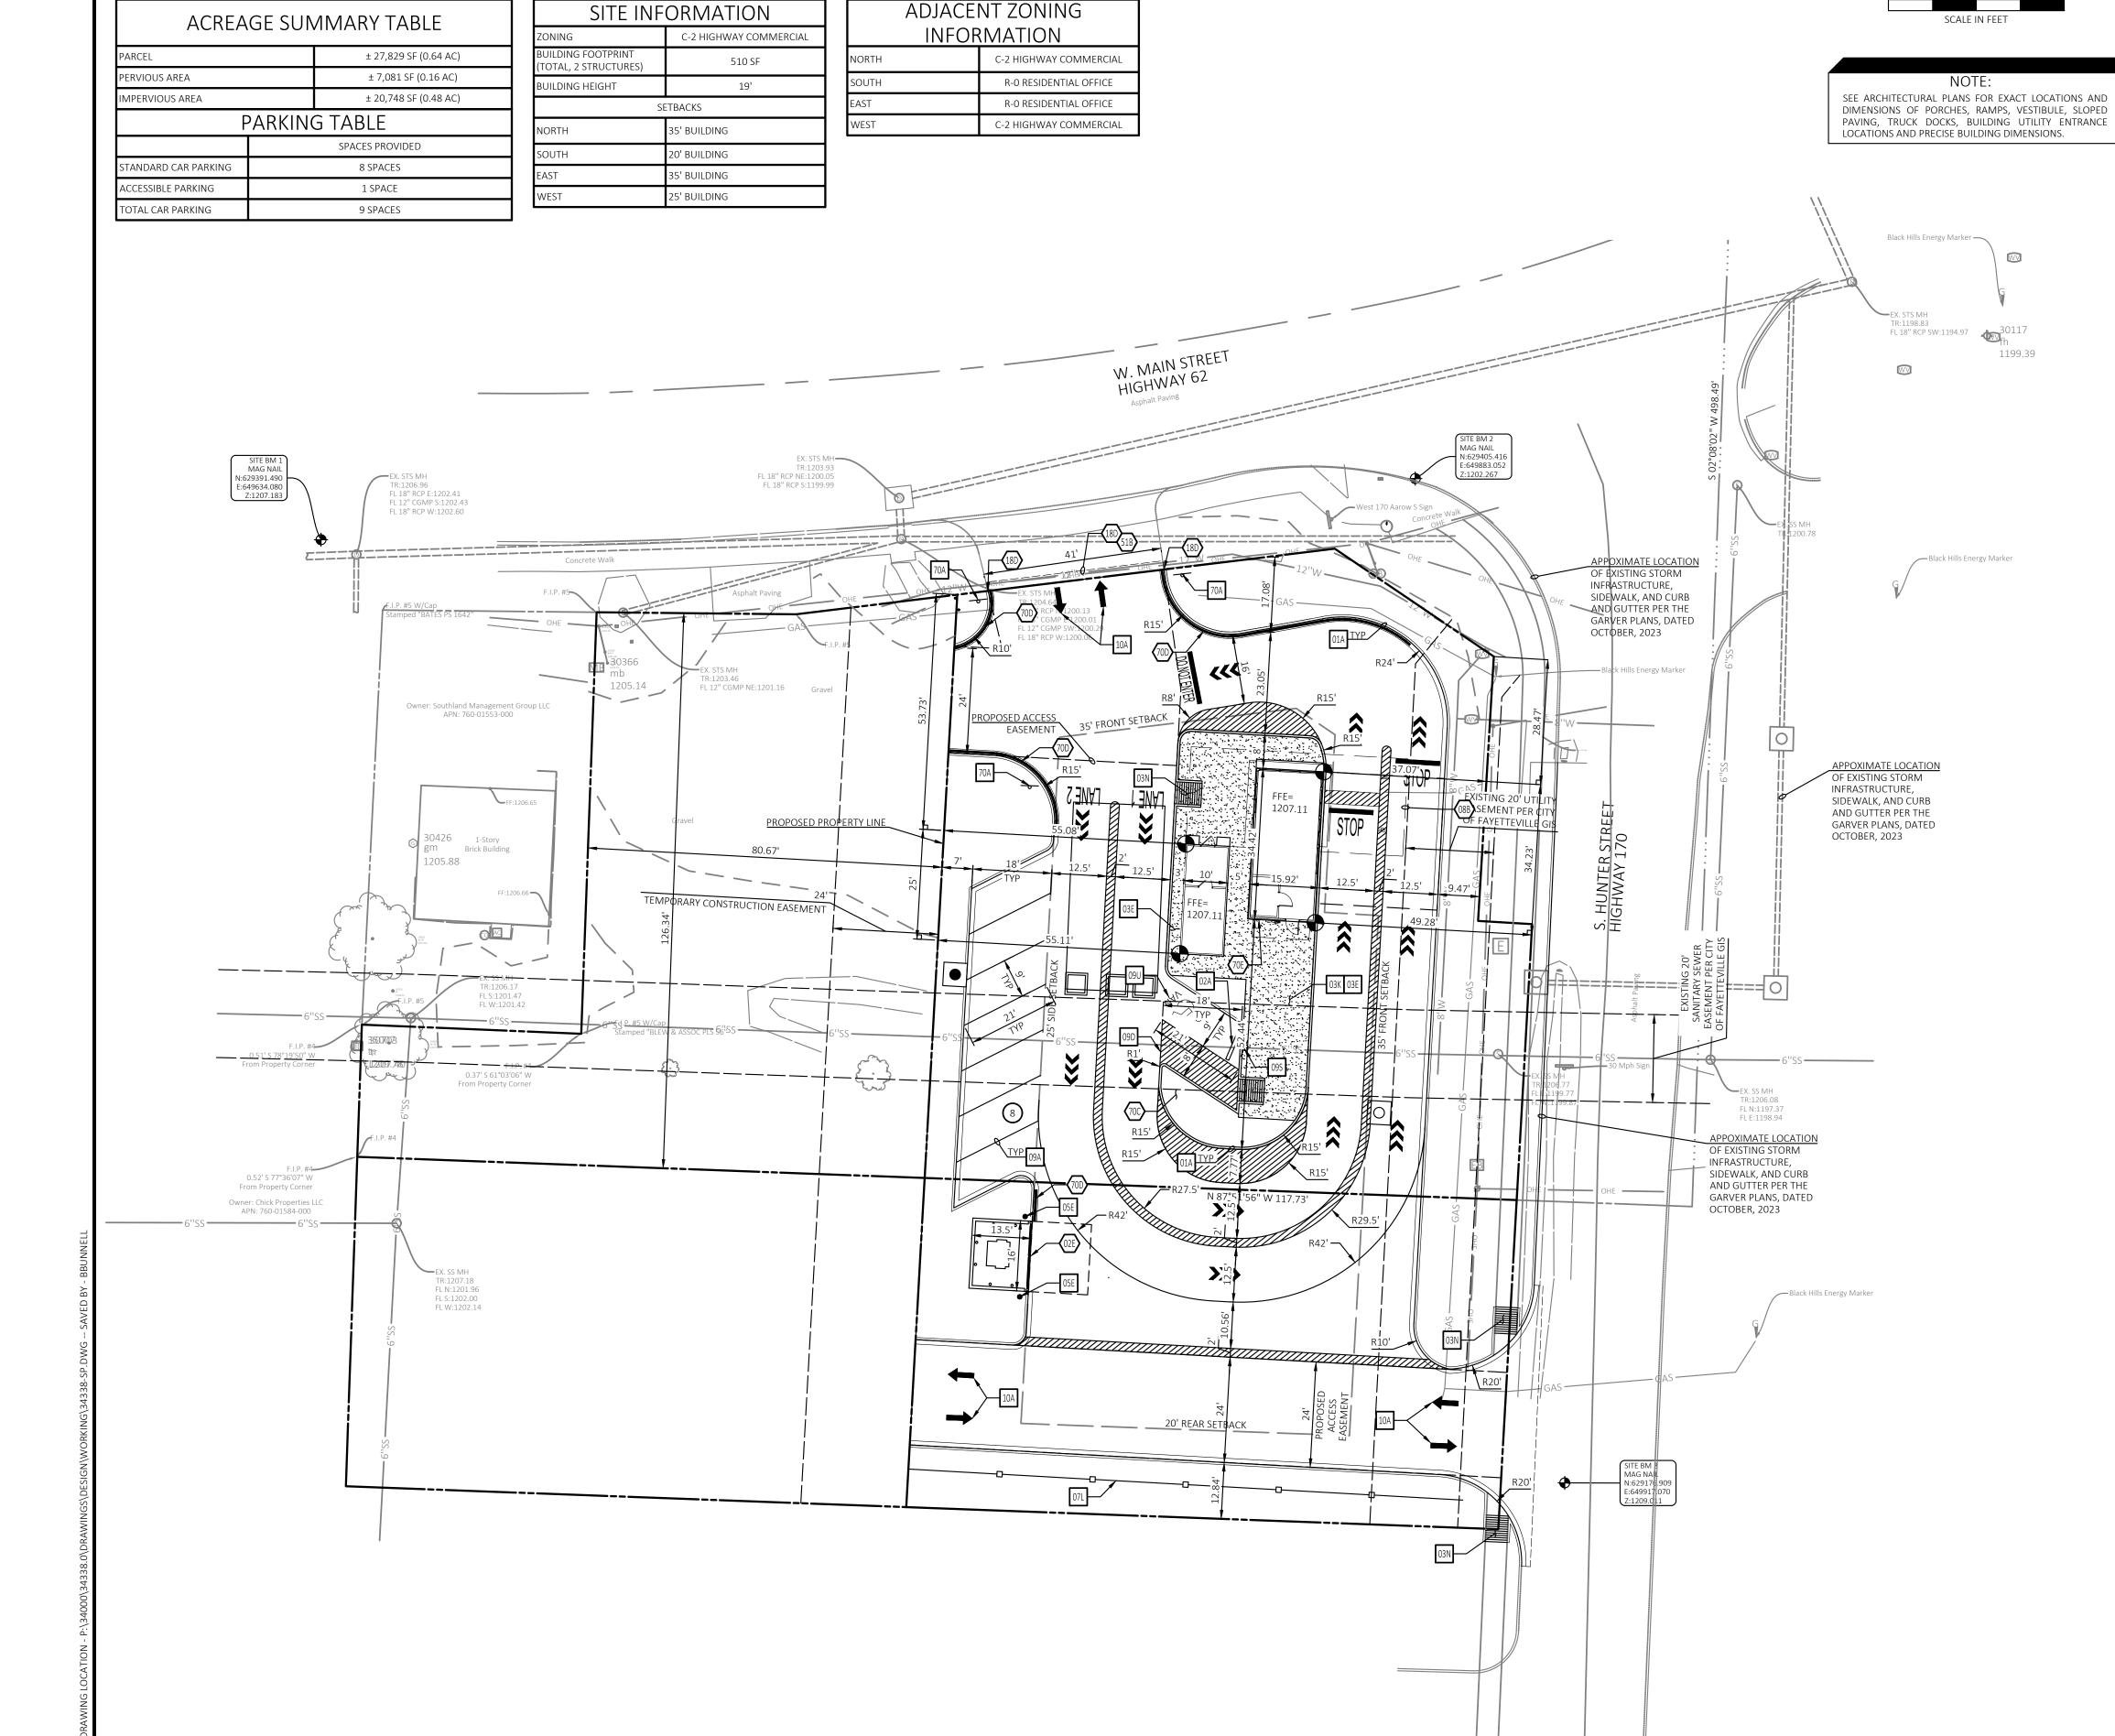

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07L WOOD FENCE

12F SIGN BASE

09A SIXTY DEGREE PARKING SPACE STRIPING


09U ACCESSIBLE PARKING SYMBOL

09D 60 DEGREE ACCESSIBLE PARKING SPACE STRIPING

10A TRAFFIC FLOW ARROW (SEE PAVING PLAN KEYNOTE 7.)

70A FIRE LANE SIGNS (PER ARKANSAS FIRE PREVENTION CODE FIGURE D103.6)

09S ACCESSIBLE / VAN ACCESSIBLE PARKING SIGN

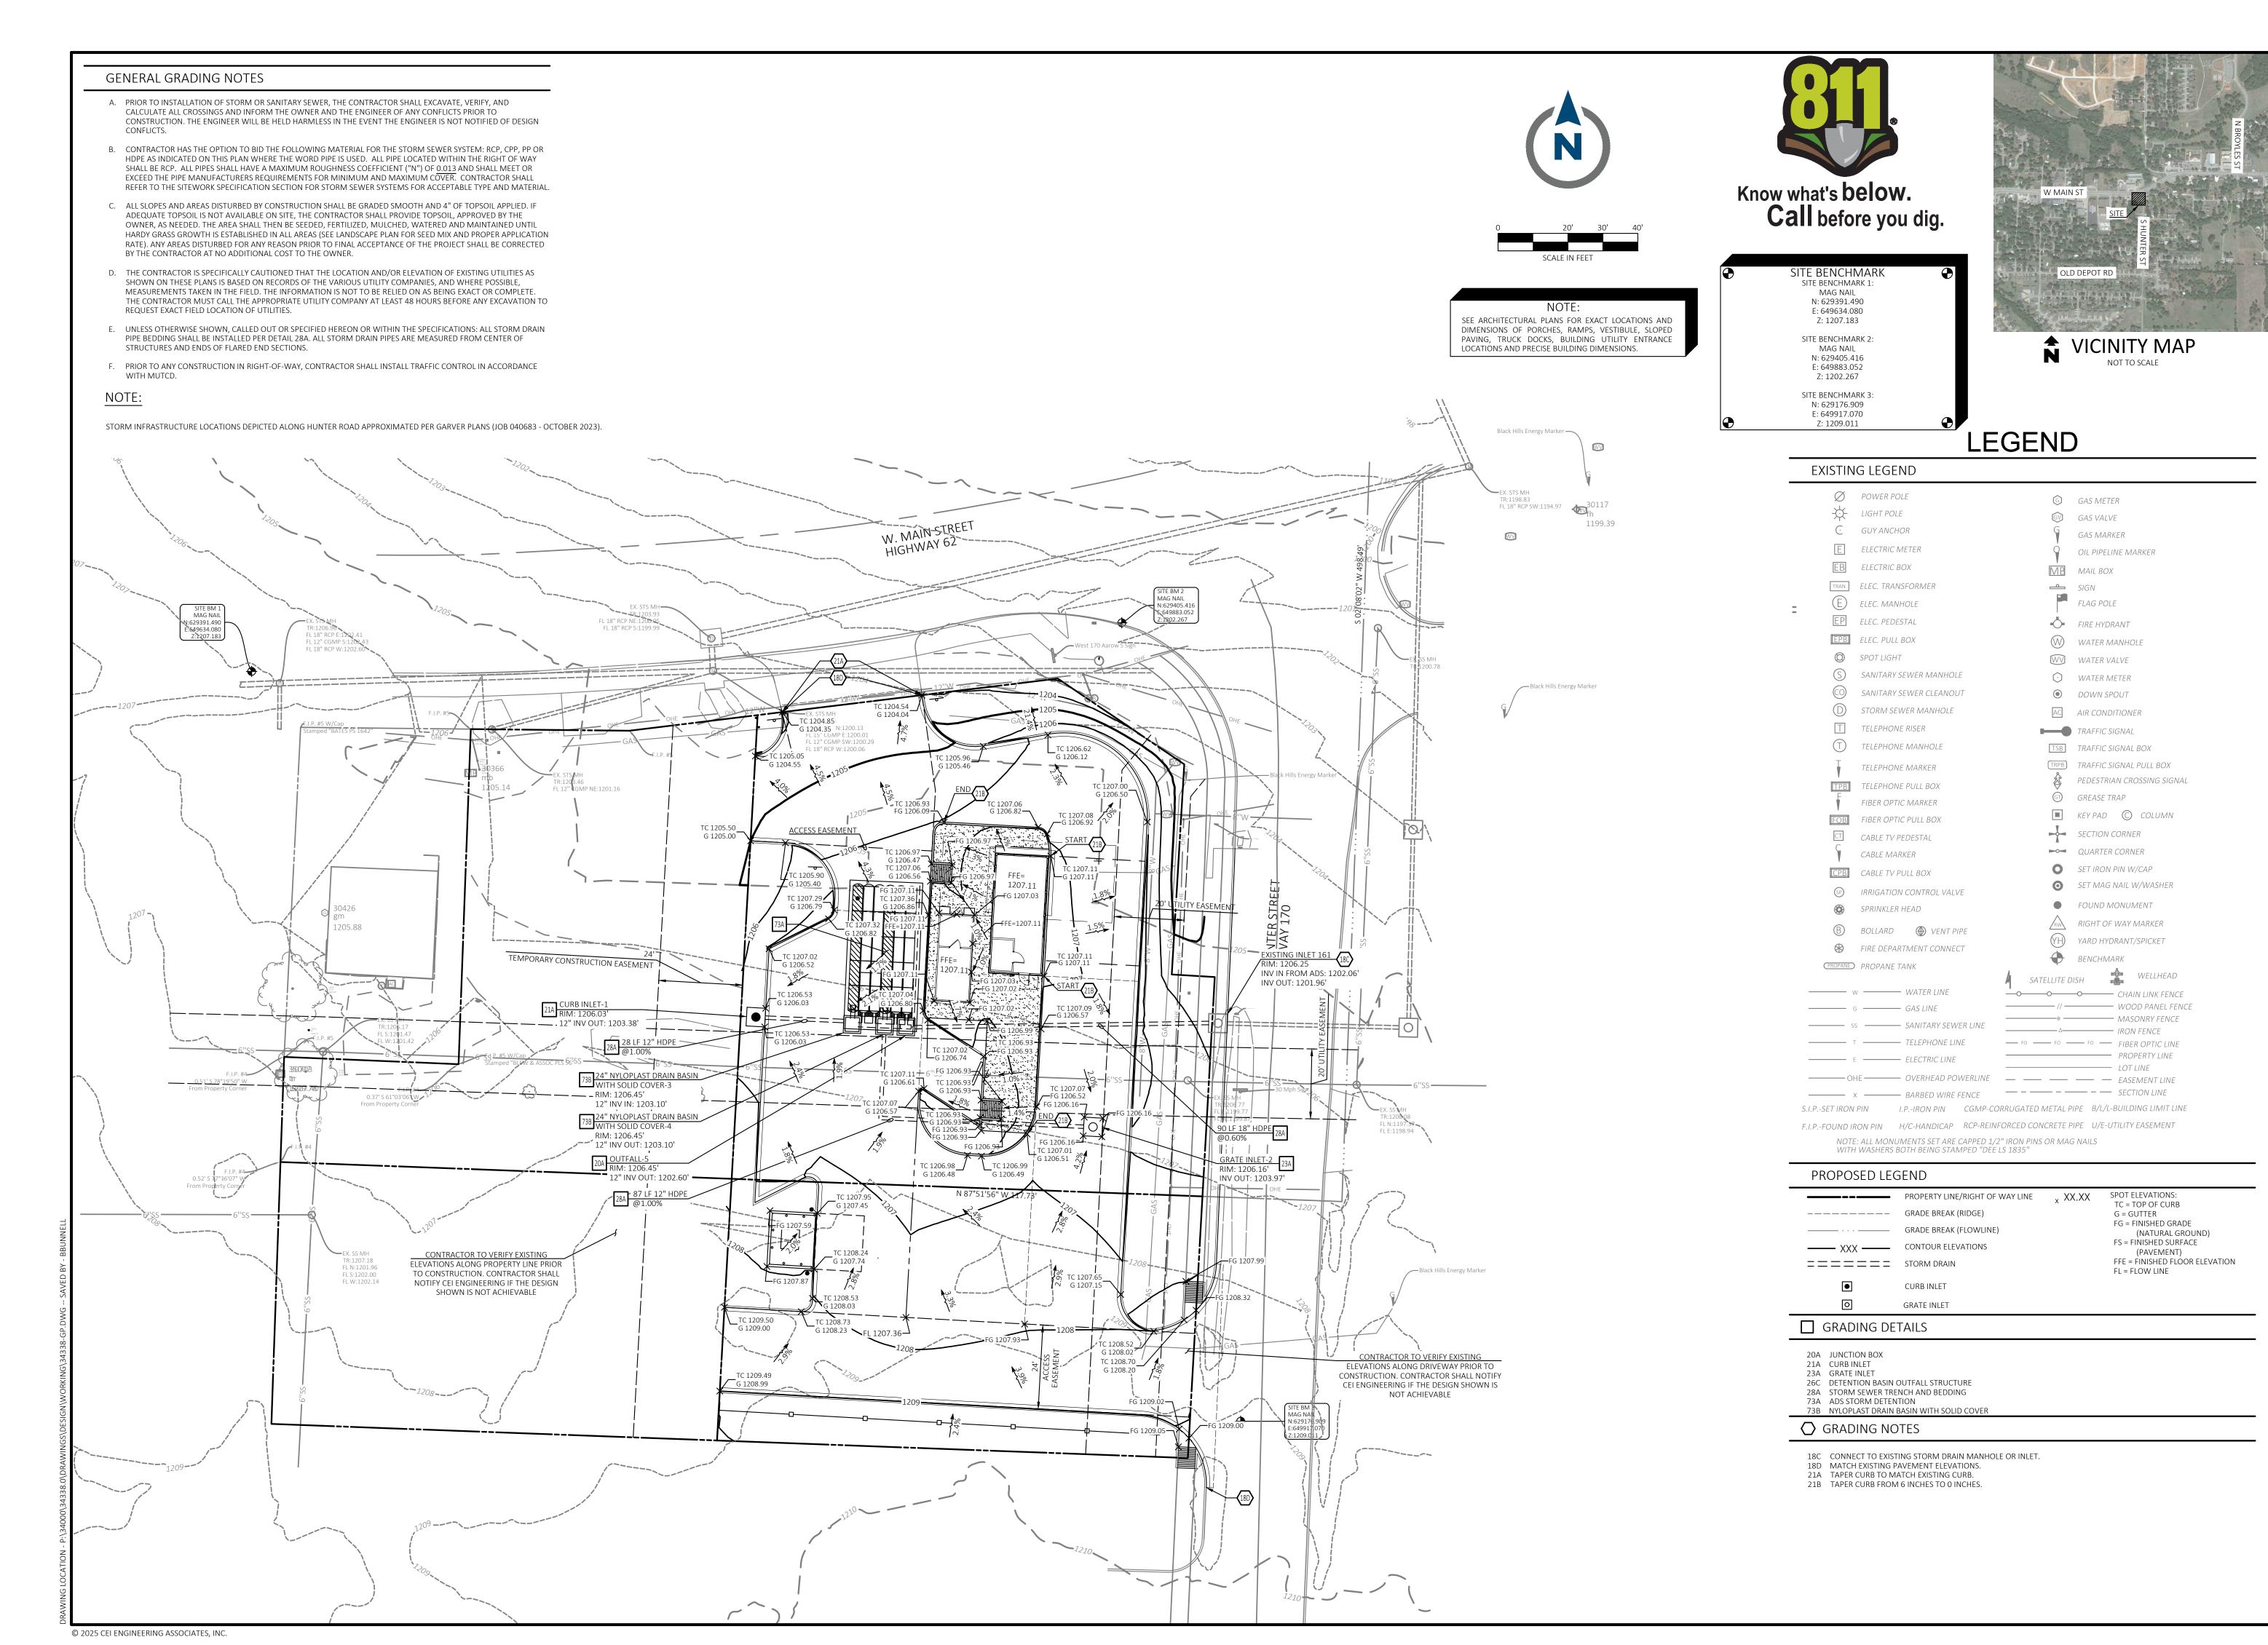

GEI GEI Solutions for Land and Life


CEI ENGINEERING ASSOCIATES, INC.

2600 NE 11TH ST, SUITE 300
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PHONE: (479) 273-9472
FAX: (479) 273-0844

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NO.	DESCRIPTION	DATE



SEVEN BREW
7 WEST MAIN STREET
FARMINGTON, ARKANSA

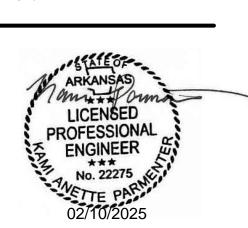

PROFESSIONAL OF RECORD	KAP
PROJECT MANAGER	EVD
DESIGNER	BWB
CEI PROJECT NUMBER	34338
DATE	2/10/2025
REVISION	REV-1

GRADING PLAN

SHEET TITLE
SHEET NUMBER

C3.0

GENERAL EROSION NOTES

BE TEMPORARILY SEEDED WITHIN 14 DAYS.

- A. ALL CONTRACTORS AND SUBCONTRACTORS INVOLVED WITH STORM WATER POLLUTION PREVENTION SHALL OBTAIN A COPY OF THE STORM WATER POLLUTION PREVENTION PLAN AND THE STATE OF ARKANSAS NATIONAL POLLUTANT DISCHARGE ELIMINATION SYSTEM GENERAL PERMIT (NPDES PERMIT) AND BECOME FAMILIAR WITH THEIR CONTENTS.
- THE TEMPORARY PARKING AND STORAGE AREA SHALL ALSO BE USED AS THE EQUIPMENT MAINTENANCE AREA, EQUIPMENT CLEANING AREA, EMPLOYEE BREAK AREA, AND AREA FOR LOCATING PORTABLE FACILITIES, OFFICE TRAILERS AND TOILET FACILITIES. THE EXACT LOCATIONS SHALL BE COORDINATED WITH THE OWNER'S CONSTRUCTION MANAGER.
- C. ALL WASH WATER (CONCRETE TRUCKS, VEHICLE CLEANING, EQUIPMENT CLEANING, ETC.) SHALL BE DISPOSED OF IN A MANNER THAT PREVENTS CONTACT BETWEEN THESE MATERIALS AND STORM WATER THAT IS
- D. MAINTAIN ON THE SITE OR HAVE READILY AVAILABLE SUFFICIENT OIL AND GREASE ABSORBING MATERIALS AND FLOTATION BOOMS TO CONTAIN AND CLEAN UP FUEL OR CHEMICAL SPILLS AND LEAKS.
- DUST ON THE SITE SHALL BE CONTROLLED BY SPRAYING WATER ON DRY AREAS OF THE SITE. THE USE OF MOTOR OILS AND OTHER PETROLEUM BASED OR TOXIC LIQUIDS FOR DUST SUPPRESSION OPERATIONS IS
- NO RUBBISH, TRASH, GARBAGE OR OTHER SUCH MATERIALS SHALL BE DISCHARGED INTO DRAINAGE DITCHES OR WATERS OF THE STATE.
- G. ALL STORM WATER POLLUTION PREVENTION MEASURES PRESENTED ON THIS PLAN, AND IN THE STORM WATER POLLUTION PREVENTION PLAN, SHALL BE INITIATED AS SOON AS PRACTICABLE.
- H. DISTURBED PORTIONS OF THE SITE WHERE CONSTRUCTION ACTIVITY WILL STOP FOR AT LEAST 21 DAYS, SHALL


- DISTURBED PORTIONS OF THE SITE WHERE CONSTRUCTION ACTIVITY HAS PERMANENTLY STOPPED SHALL BE PERMANENTLY SEEDED. THESE AREAS SHALL BE SEEDED NO LATER THAN 14 DAYS AFTER THE LAST CONSTRUCTION ACTIVITY OCCURRING IN THESE AREAS. REFER TO THE LANDSCAPING PLAN.
- J. IF THE ACTION OF VEHICLES TRAVELING OVER THE GRAVEL CONSTRUCTION ENTRANCES IS NOT SUFFICIENT TO REMOVE THE MAJORITY OF DIRT OR MUD, THEN THE TIRES MUST BE WASHED BEFORE THE VEHICLES ENTER A PUBLIC ROAD. IF WASHING IS USED, PROVISIONS MUST BE MADE TO INTERCEPT THE WASH WATER AND TRAP THE SEDIMENT BEFORE IT IS CARRIED OFF THE SITE. THE EXACT LOCATIONS SHALL BE COORDINATED WITH THE OWNERS CONSTRUCTION MANAGER.
- K. ALL MATERIALS SPILLED, DROPPED, WASHED OR TRACKED FROM VEHICLES ONTO ROADWAYS OR INTO STORM DRAINS MUST BE REMOVED IMMEDIATELY.
- CONTRACTORS OR SUBCONTRACTORS WILL BE RESPONSIBLE FOR REMOVING SEDIMENT IN THE DETENTION POND AFTER THE STABILIZATION OF THE SITE AND ALSO ANY SEDIMENT THAT MAY HAVE COLLECTED IN THE STORM SEWER DRAINAGE SYSTEMS.
- M. IF SOIL STOCKPILING IS EMPLOYED ON THE SITE, SILT FENCES SHALL BE USED TO HELP CONTAIN THE SEDIMENT.
- N. SLOPES SHALL BE LEFT IN A ROUGHENED CONDITION DURING THE GRADING PHASE TO REDUCE RUNOFF VELOCITIES AND EROSION.
- SEDIMENT BASINS ARE ATTRACTIVE TO CHILDREN AND CAN BE VERY DANGEROUS. IN ALL CASES, LOCAL ORDINANCES AND REGULATIONS REGARDING HEALTH AND SAFETY MUST BE ADHERED TO.
- ALL TEMPORARY EROSION AND SEDIMENT CONTROL MEASURES SHALL BE DISPOSED OF WITHIN 30 DAYS AFTER FINAL STABILIZATION. FINAL STABILIZATION HAS OCCURRED WHEN ALL SOIL DISTURBING ACTIVITIES ARE COMPLETED AND A UNIFORM PERENNIAL VEGETATIVE COVER WITH A DENSITY OF 70% OF THE COVER FOR UNPAVED AREAS AND AREAS NOT COVERED BY PERMANENT STRUCTURES HAS BEEN EMPLOYED

- DUE TO THE GRADE CHANGES DURING THE DEVELOPMENT OF THE PROJECT, THE CONTRACTOR SHALL BE RESPONSIBLE FOR ADJUSTING THE EROSION CONTROL MEASURES (SILT FENCES, STRAW BALES, ETC.) TO HELP PREVENT EROSION AND STORM WATER POLLUTION.
- ALL OFF-SITE CONSTRUCTION SHALL BE STABILIZED AT THE END OF EACH WORKING DAY. THIS INCLUDES BACKFILLING OF TRENCHES FOR STORM DRAINS & UTILITY CONSTRUCTION AND PLACEMENT OF GRAVEL OR BITUMINOUS PAVING FOR ROAD CONSTRUCTION.
- PREVENTION PLAN, SHALL BE MAINTAINED IN FULLY FUNCTIONAL CONDITION UNTIL FINAL STABILIZATION OF THE SITE. ALL EROSION AND SEDIMENTATION CONTROL MEASURES SHALL BE CHECKED BY A QUALIFIED PERSON AT LEAST ONCE EVERY SEVEN CALENDAR DAYS AND WITHIN 24 HOURS OF THE END OF A RAINFALL EVENT, AND SHOULD BE CLEANED AND REPAIRED IN ACCORDANCE WITH THE FOLLOWING:

ALL MEASURES STATED ON THIS EROSION AND SEDIMENT CONTROL PLAN, AND IN THE STORM WATER POLLUTION

- 1. ALL SEEDED AREAS SHALL BE CHECKED REGULARLY TO SEE THAT A GOOD STAND IS MAINTAINED. AREAS SHOULD BE FERTILIZED AND RESEEDED AS NEEDED.
- 2. SILT FENCES SHALL BE REPAIRED TO THEIR ORIGINAL CONDITIONS IF DAMAGED. SEDIMENT SHALL BE REMOVED FROM THE SILT FENCES WHEN IT REACHES ONE-THIRD TO ONE-HALF THE HEIGHT OF THE SILT FENCE.
- 3. THE CONSTRUCTION ENTRANCES SHALL BE MAINTAINED IN A CONDITION WHICH WILL PREVENT TRACKING OR FLOW OF MUD ONTO PUBLIC RIGHTS-OF-WAY. THIS MAY REQUIRE PERIODIC TOP DRESSING OF THE CONSTRUCTION ENTRANCES AS CONDITIONS DEMAND.
- 4. THE TEMPORARY PARKING AND STORAGE AREA SHALL BE KEPT IN GOOD CONDITION (SUITABLE FOR PARKING AND STORAGE). THIS MAY REQUIRE PERIODIC TOP DRESSING OF THE TEMPORARY PARKING AS CONDITIONS
- 5. IF THE STONES IN THE GRAVEL INLET SEDIMENT FILTERS BECOME CLOGGED WITH SEDIMENT, THE STONES MUST BE PULLED AWAY, CLEANED AND REPLACED.



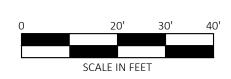


SEE ARCHITECTURAL PLANS FOR EXACT LOCATIONS AND DIMENSIONS OF PORCHES, RAMPS, VESTIBULE, SLOPED PAVING, TRUCK DOCKS, BUILDING UTILITY ENTRANCE LOCATIONS AND PRECISE BUILDING DIMENSIONS.




Know what's **below**. **Call** before you dig.

SITE BENCHMARK SITE BENCHMARK 1: MAG NAIL N: 629391.490 E: 649634.080 Z: 1207.183 SITE BENCHMARK 2: MAG NAIL N: 629405.416 E: 649883.052 Z: 1202.267

> SITE BENCHMARK 3: N: 629176.909 E: 649917.070 Z: 1209.011

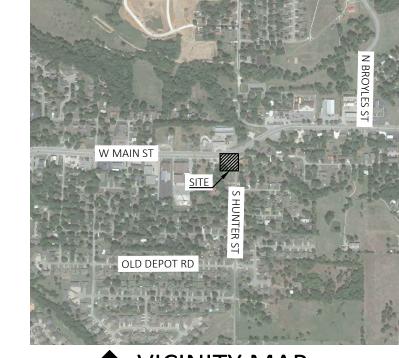

\$ VICINITY MAP

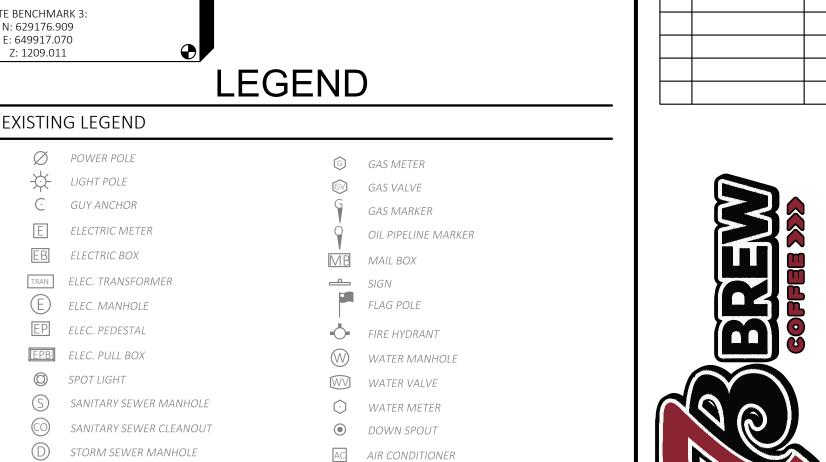

TSB TRAFFIC SIGNAL BOX (TRPB) TRAFFIC SIGNAL PULL BOX PEDESTRIAN CROSSING SIGNAL GT GREASE TRAP KEY PAD © COLUMN SECTION CORNER QUARTER CORNER

TRAFFIC SIGNAL

SET MAG NAIL W/WASHER © IRRIGATION CONTROL VALVE FOUND MONUMENT SPRINKLER HEAD RIGHT OF WAY MARKER B) BOLLARD DENT PIPE (YH) YARD HYDRANT/SPICKET FIRE DEPARTMENT CONNECT **BENCHMARK** PROPANE TANK

SATELLITE DISH w ----- WATER LINE G GAS LINE ------ ss ------ SANITARY SEWER LINI ── T ── TELEPHONE LINE OHE — OVERHEAD POWERLINE _ _ _ — EASEMENT LINE — x — BARBED WIRE FENCE — — — — SECTION LINE S.I.P.-SET IRON PIN I.P.-IRON PIN CGMP-CORRUGATED METAL PIPE B/L/L-BUILDING LIMIT LINE

F.I.P.-FOUND IRON PIN H/C-HANDICAP RCP-REINFORCED CONCRETE PIPE U/E-UTILITY EASEMENT

NOTE: ALL MONUMENTS SET ARE CAPPED 1/2" IRON PINS OR MAG NAILS

PROPOSED LEGEND

SILT FENCE

T TELEPHONE RISER

(T) TELEPHONE MANHOLE

TPB TELEPHONE PULL BOX

FOB FIBER OPTIC PULL BOX

CABLE MARKER

CT CABLE TV PEDESTAL


CPB CABLE TV PULL BOX

TELEPHONE MARKER

FIBER OPTIC MARKER

PROPERTY LINE/RIGHT OF WAY LINE LIMITS OF DISTURBANCE CONTOUR ELEVATIONS ---- GRADE BREAK ____ _ _ FLOWLINE ======= STORM DRAIN

WITH WASHERS BOTH BEING STAMPED "DEE LS 1835"

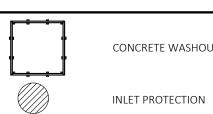

CONCRETE WASHOUT

CONSTRUCTION ENTRANCE

SWP-CI (BIG RED)

AREA OF DISTURBANCE = 0.83 ACRES (36,125 S.F.)

SOIL TYPES

PEMBROKE SILT LOAM, 3-6% SLOPES, ERODED

APPROXIMATE LIMITS OF SOIL TYPE

☐ EROSION DETAILS

74A BIG RED

75C SILT FENCE 80F TEMPORARY SILT FENCE INLET PROTECTION

85A TEMPORARY STONE CONSTRUCTION ENTRANCE 85C TEMPORARY CONCRETE WASH OUT

LICENSED PROFESSIONAL ENGINEER

BR AIN S TON,

CEI ENGINEERING ASSOCIATES, INC.

2600 NE 11TH ST, SUITE 300

BENTONVILLE, AR 72712

PHONE: (479) 273-9472

FAX: (479) 273-0844


REVISION


DATE

NO. DESCRIPTION

PROFESSIONAL OF RECORD PROJECT MANAGER EVD DESIGNER BWB CEI PROJECT NUMBER 2/10/2025 REVISION

EROSION CONTROL PLAN

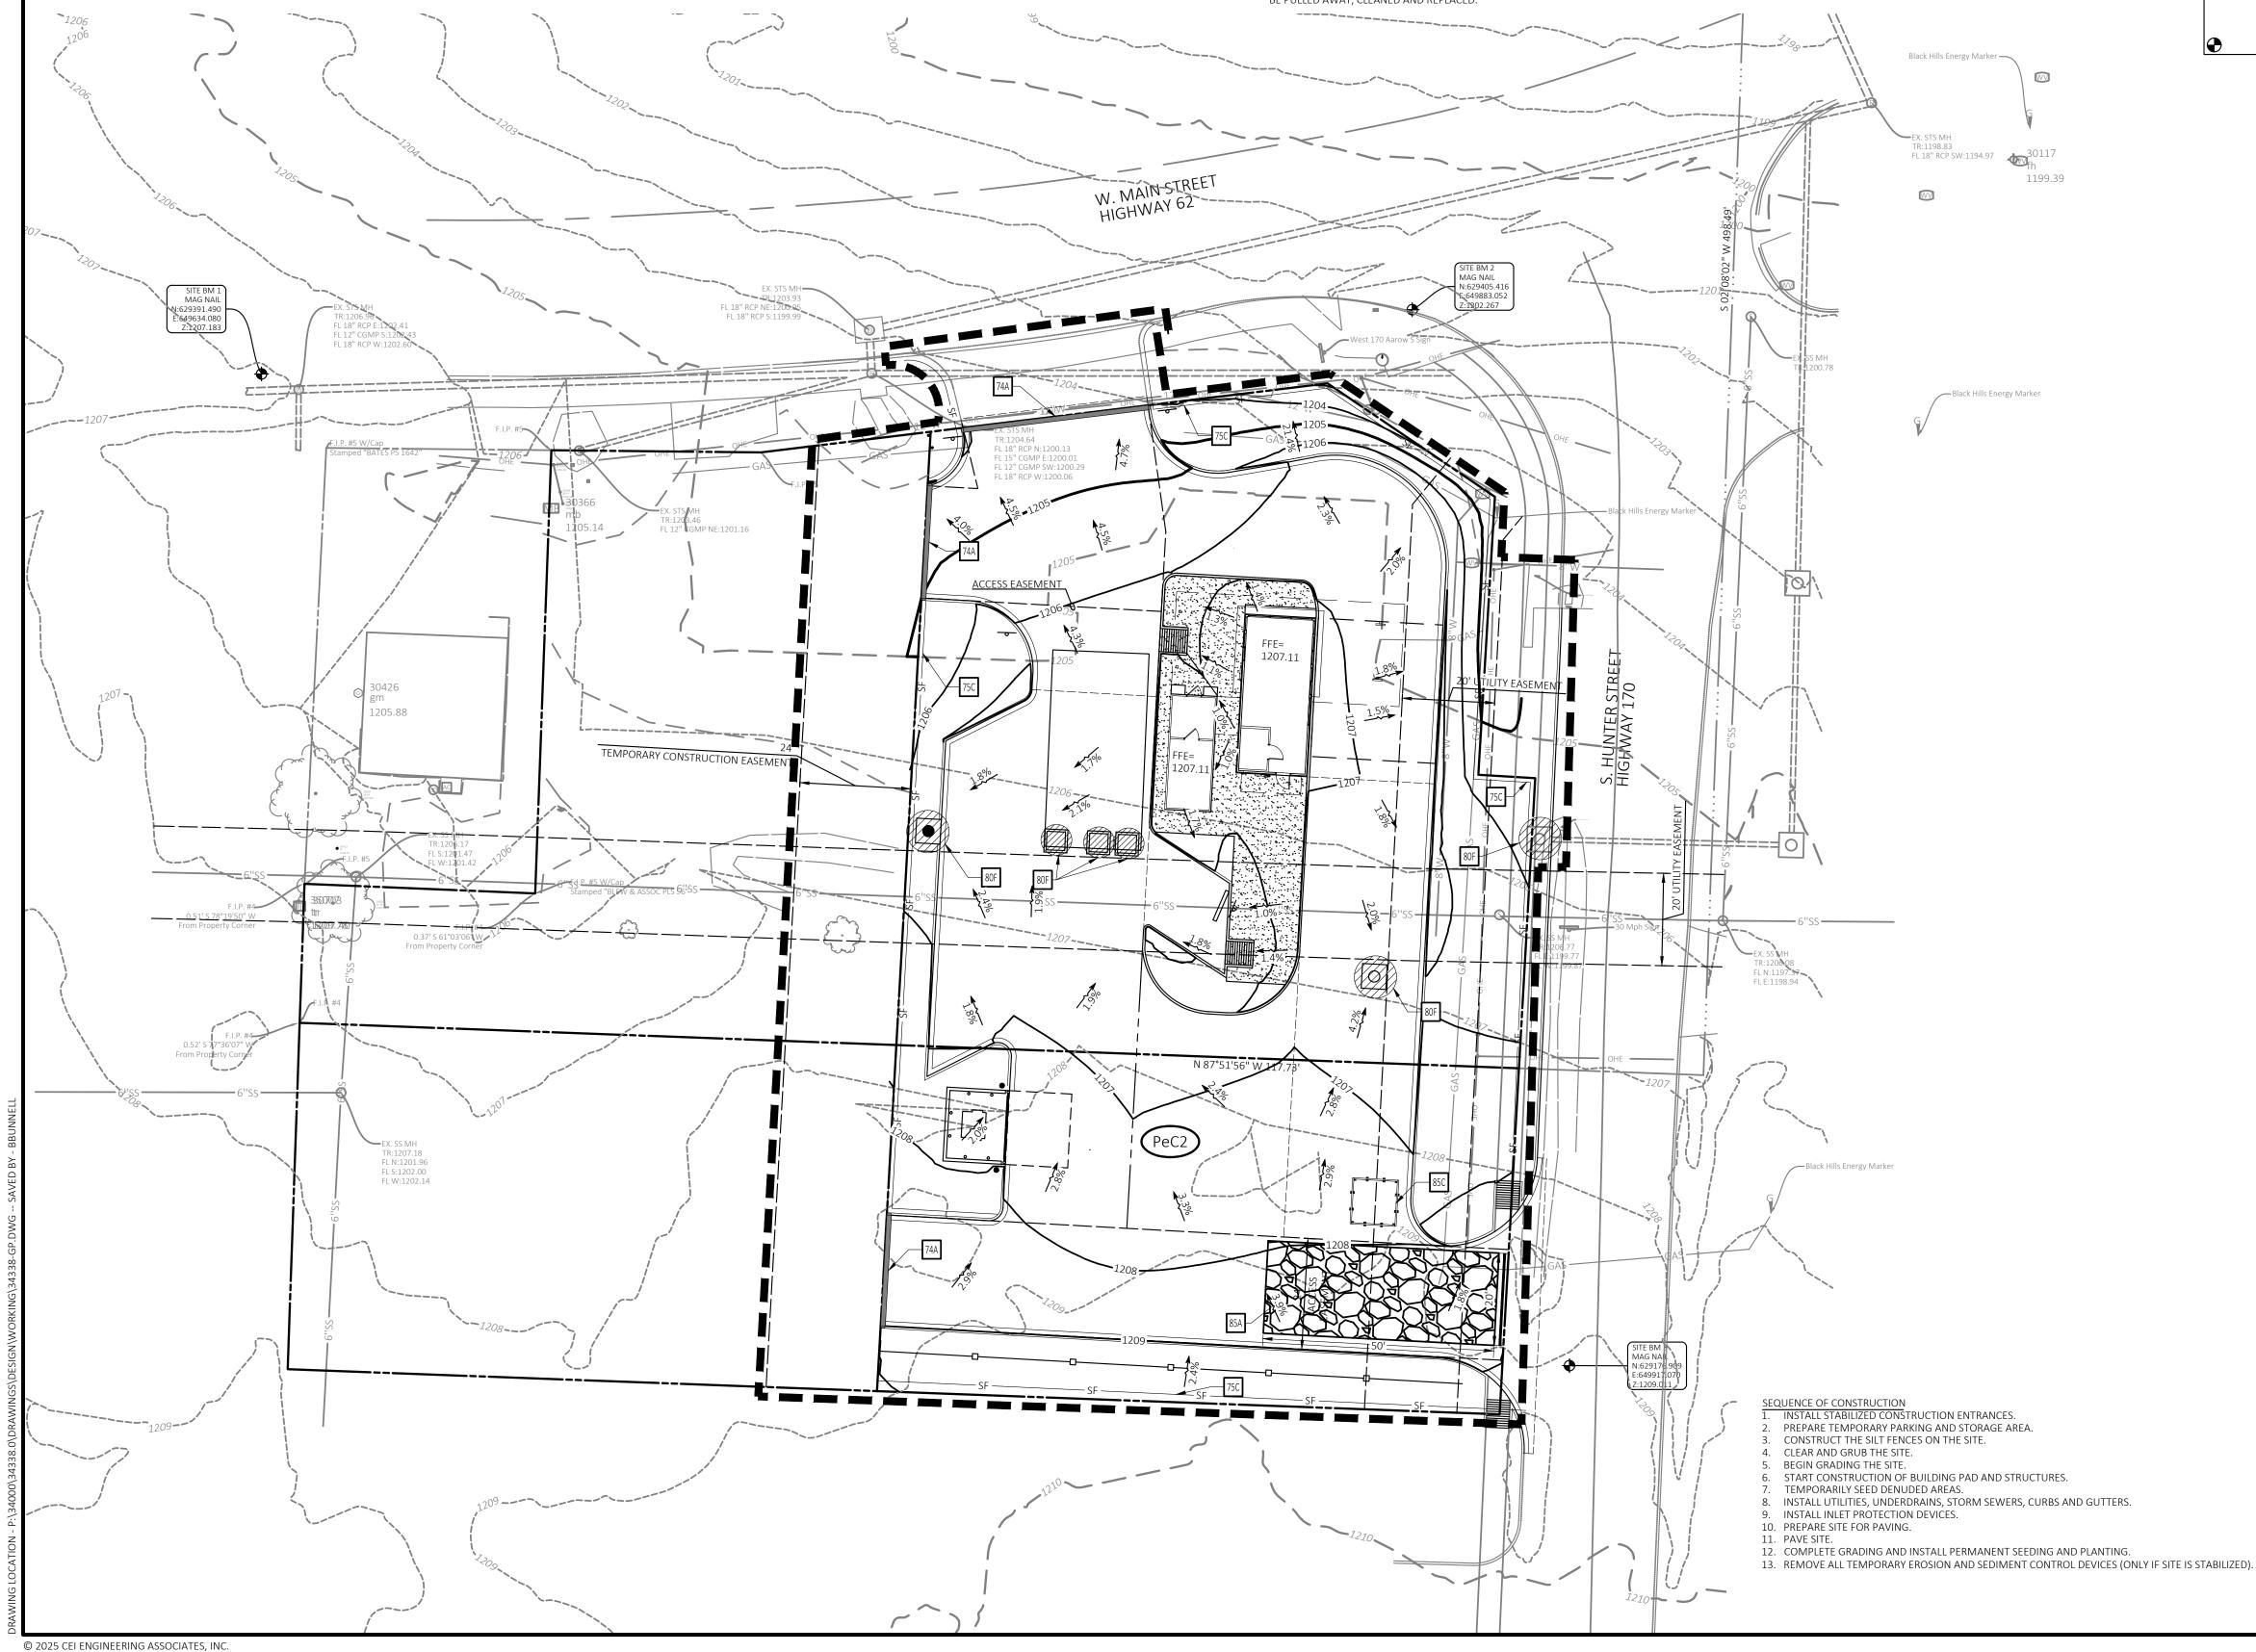

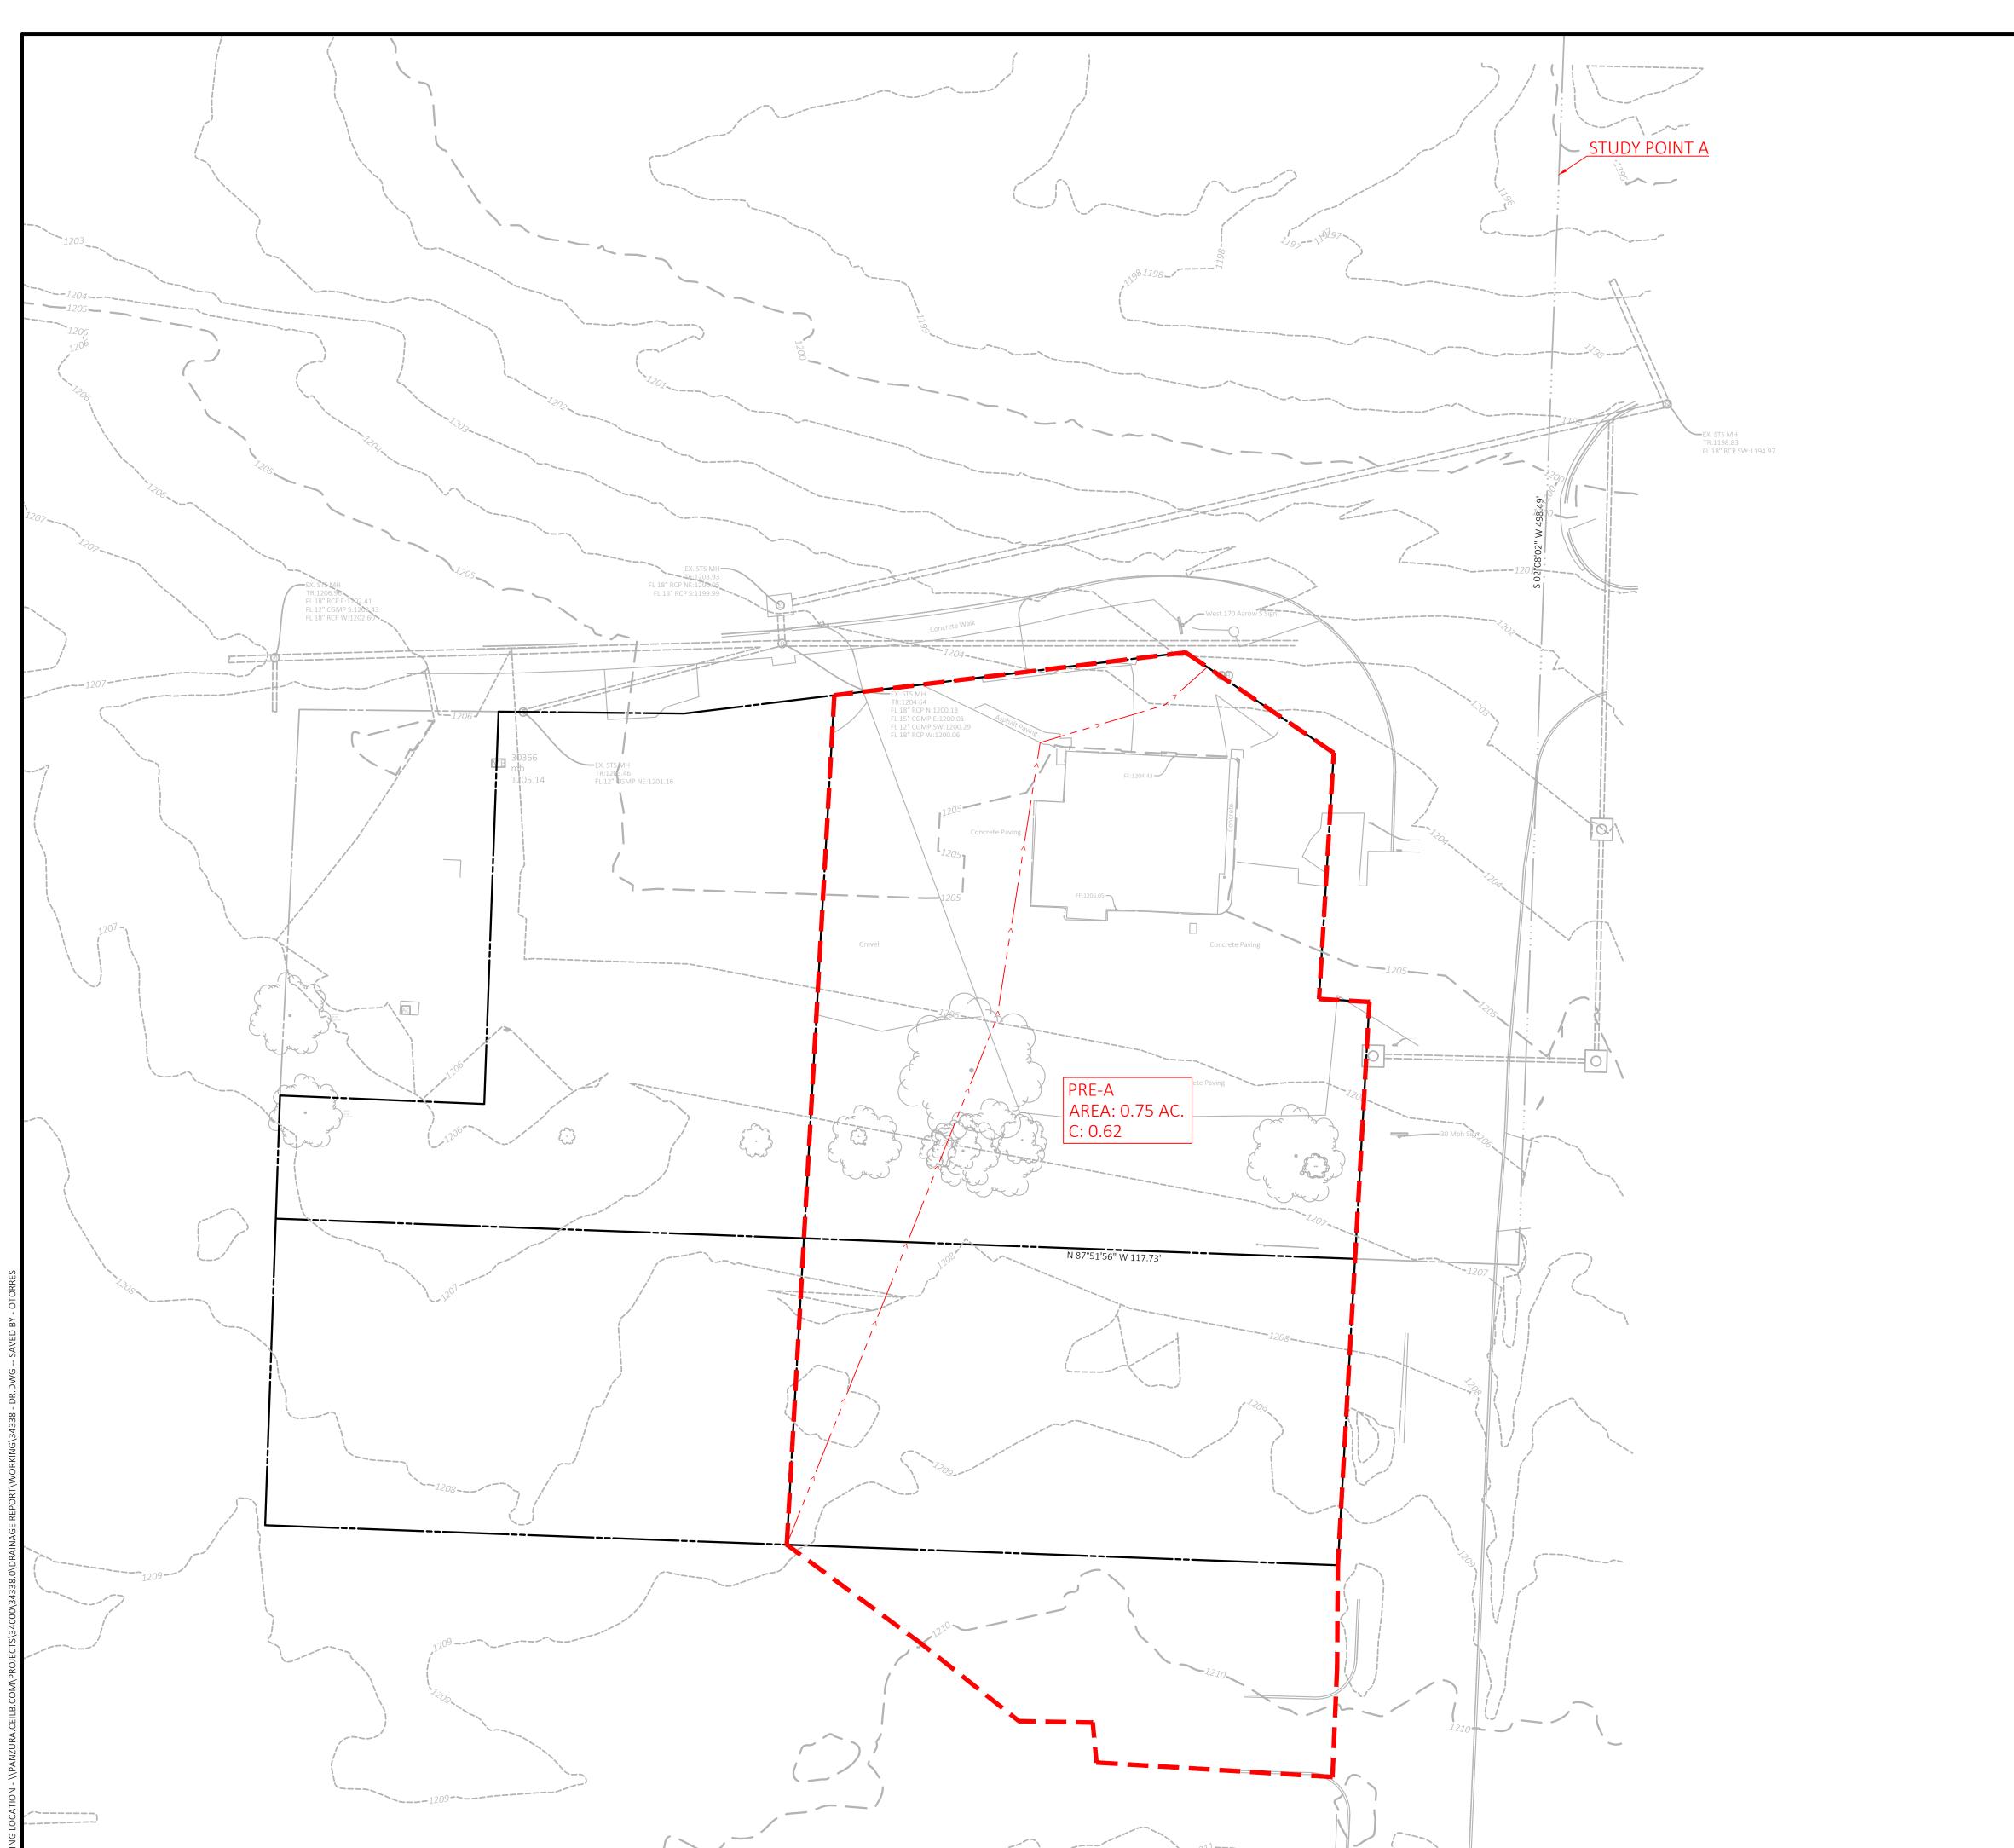





Know what's below.
Call before you dig.

EXISTING LEGEND

\varnothing	POWER POLE	
*	LIGHT POLE	€ GAS VALVE
$\overline{\cdot}$	GUY ANCHOR	G GAS MARKER
E	ELECTRIC METER	OIL PIPELINE MARKER
EB	ELECTRIC BOX	MB MAIL BOX
TRAN	ELEC. TRANSFORMER	→ SIGN
E	ELEC. MANHOLE	FLAG POLE
EP	ELEC. PEDESTAL	- FIRE HYDRANT
EPB	ELEC. PULL BOX	W WATER MANHOLE
	SPOT LIGHT	WV WATER VALVE
S	SANITARY SEWER MANHOLE	○ WATER METER
	SANITARY SEWER CLEANOUT	DOWN SPOUT
	STORM SEWER MANHOLE	AC AIR CONDITIONER
\Box	TELEPHONE RISER	TRAFFIC SIGNAL
\bigcirc	TELEPHONE MANHOLE	TSB TRAFFIC SIGNAL BOX
Ţ	TELEPHONE MARKER	TRAFFIC SIGNAL PULL BOX
TPB	TELEPHONE PULL BOX	PEDESTRIAN CROSSING SIGNAL
Ţ	FIBER OPTIC MARKER	GT GREASE TRAP
FOB	FIBER OPTIC PULL BOX	KEY PAD C COLUMN
CT	CABLE TV PEDESTAL	SECTION CORNER
C	CABLE MARKER	QUARTER CORNER
СРВ	CABLE TV PULL BOX	SET IRON PIN W/CAP
(SP)	IRRIGATION CONTROL VALVE	SET MAG NAIL W/WASHER
	SPRINKLER HEAD	FOUND MONUMENT
(B)	BOLLARD (VENT PIPE	RIGHT OF WAY MARKER
⊗	FIRE DEPARTMENT CONNECT	YH YARD HYDRANT/SPICKET
(PROPANE)		BENCHMARK
		SATELLITE DISH WELLHEAD
	WATER LINE	CHAIN LINK FENCE
(GAS LINE	WOOD PANEL FENCE MASONRY FENCE
S		IRON FENCE
	TELEPHONE LINE	FIBER OPTIC LINE PROPERTY LINE
		LOT LINE
OI	HE — OVERHEAD POWERLINE	EASEMENT LINE
.PSET IRON	x ———— BARBED WIRE FENCE PIN I.PIRON PIN CGMP-C	SECTION LINE ORRUGATED METAL PIPE B/L/L-BUILDING LIMIT LINE

PROPOSED LEGEND

PRE-DEVELOPED DRAINAGE BASIN LIMITS
TIME OF CONCENTRATION PATH

NOTE


STORM INFRASTRUCTURE LOCATIONS DEPICTED ALONG HUNTER RD APPROXIMATED PER GARVER PLANS (HWY. 62 - CLYDE CARNES RD. (HWY. 170) (FARMINGTON) (S) WASHINGTON COUNTY F.A.P. STPU-9141(1) JOB 040683)

NOTE: ALL MONUMENTS SET ARE CAPPED 1/2" IRON PINS OR MAG NAILS WITH WASHERS BOTH BEING STAMPED "DEE LS 1835"



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7 WEST MAIN STREET FARMINGTON, ARKANSAS

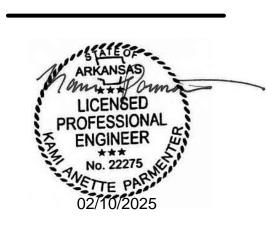


PROFESSIONAL OF RECORD	KAP
PROJECT MANAGER	EVD
DESIGNER	BWB
CEI PROJECT NUMBER	34338
DATE	2/10/2025
REVISION	REV-1

PRE-DEVELOPMENT DRAINAGE MAP

SHEET TITLE
SHEET NUMBER

25.0

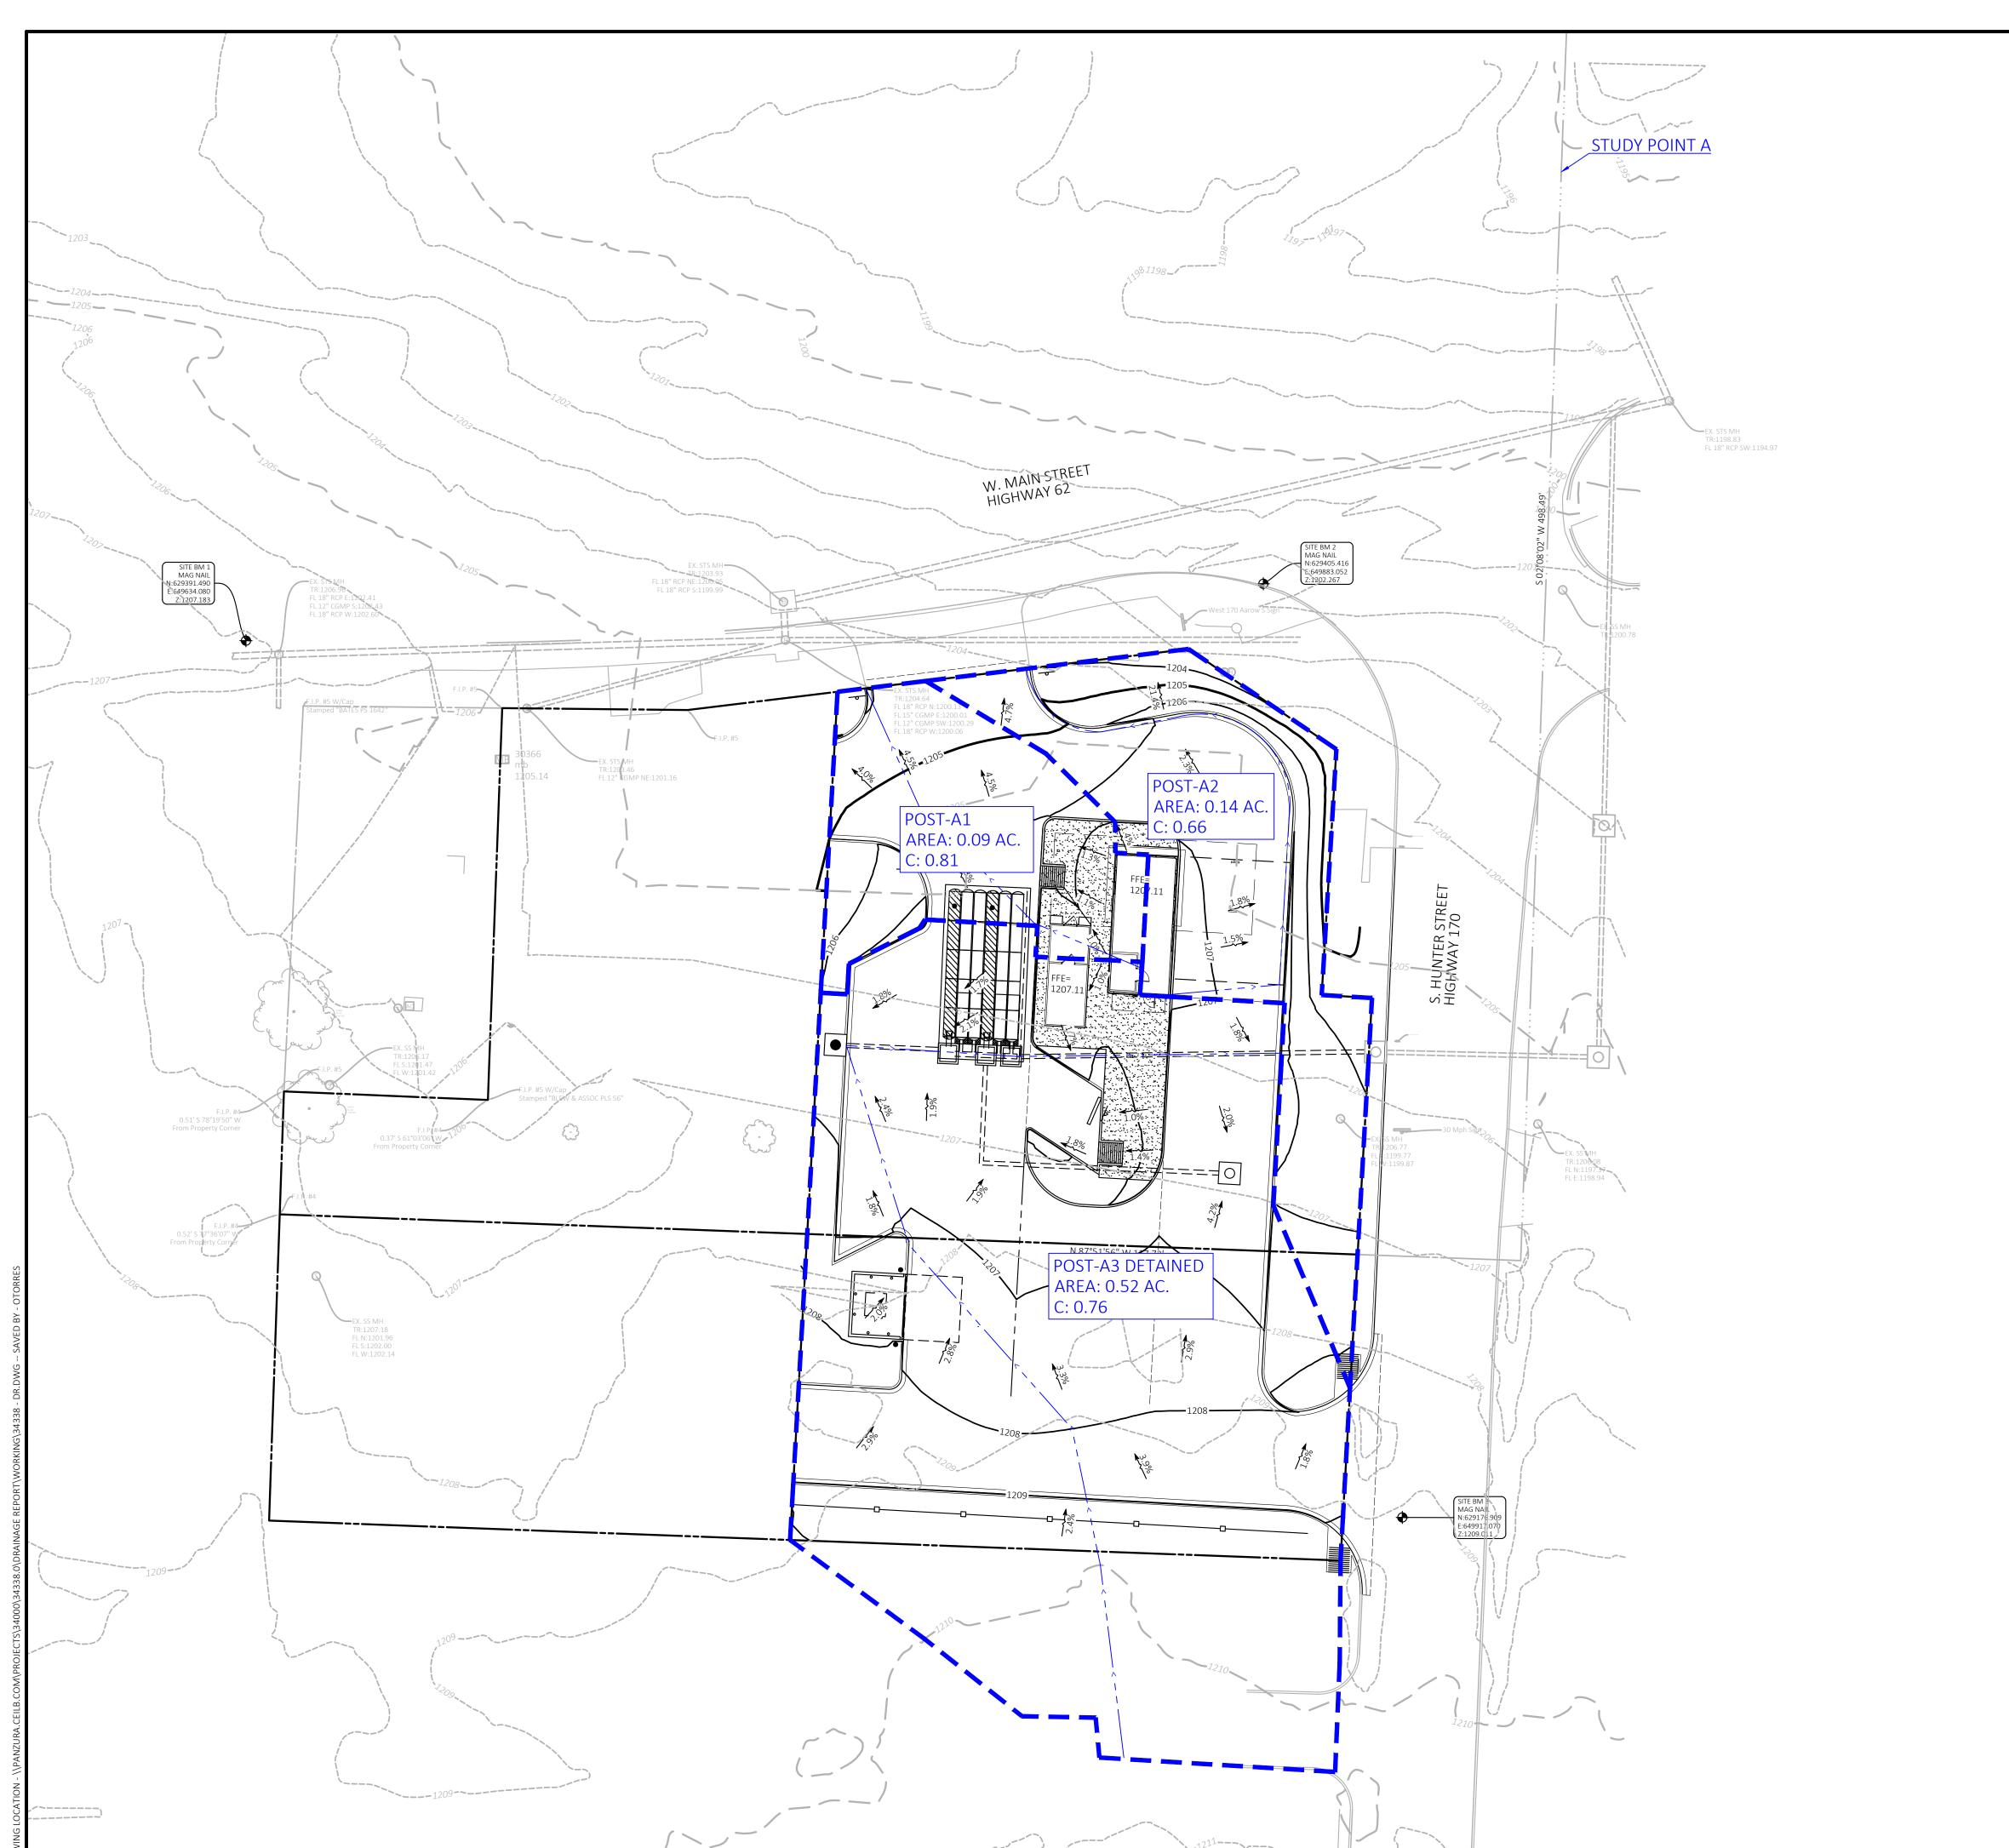



G GAS METER

GV GAS VALVE

GEI

Solutions for Land and Life

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BENTONVILLE, AR 72712
PHONE: (479) 273-9472
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 GUY ANCHOR GAS MARKER E ELECTRIC METER OIL PIPELINE MARKER EB ELECTRIC BOX MB MAIL BOX TRAN ELEC. TRANSFORMER SIGN FLAG POLE E ELEC. MANHOLE EP ELEC. PEDESTAL FIRE HYDRANT EPB ELEC. PULL BOX WATER MANHOLE SPOT LIGHT WV WATER VALVE S SANITARY SEWER MANHOLE WATER METER SANITARY SEWER CLEANOUT DOWN SPOUT (D) STORM SEWER MANHOLE AC AIR CONDITIONER T TELEPHONE RISER TRAFFIC SIGNAL (T) TELEPHONE MANHOLE TSB TRAFFIC SIGNAL BOX TRAFFIC SIGNAL PULL BOX TELEPHONE MARKER PEDESTRIAN CROSSING SIGNAL TPB TELEPHONE PULL BOX GT GREASE TRAP FIBER OPTIC MARKER KEY PAD © COLUMN FOB FIBER OPTIC PULL BOX SECTION CORNER CT CABLE TV PEDESTAL QUARTER CORNER CABLE MARKER SET IRON PIN W/CAP CPB CABLE TV PULL BOX SET MAG NAIL W/WASHER SP IRRIGATION CONTROL VALVE FOUND MONUMENT SPRINKLER HEAD RIGHT OF WAY MARKER B BOLLARD • VENT PIPE YH) YARD HYDRANT/SPICKET BENCHMARK PROPANE TANK ---- WATER LINE CHAIN LINK FENCE MASONRY FENCE ------ ss ------- SANITARY SEWER LINE TELEPHONE LINE FIBER OPTIC LINE PROPERTY LINE ELECTRIC LINE EASEMENT LINE SECTION LINE — X — BARBED WIRE FENCE S.I.P.-SET IRON PIN I.P.-IRON PIN CGMP-CORRUGATED METAL PIPE B/L/L-BUILDING LIMIT LINE F.I.P.-FOUND IRON PIN H/C-HANDICAP RCP-REINFORCED CONCRETE PIPE U/E-UTILITY EASEMENT NOTE: ALL MONUMENTS SET ARE CAPPED 1/2" IRON PINS OR MAG NAILS WITH WASHERS BOTH BEING STAMPED "DEE LS 1835"

PROPOSED LEGEND

EXISTING LEGEND


Ø POWER POLE

LIGHT POLE

	POST-DEVELOPED DRAINAGE BASIN LIMITS	— XXX —	CONTOUR ELEVATIO
——————————————————————————————————————	TIME OF CONCENTRATION PATH		FLOWLINE
	GRADE BREAK	======	STORM DRAIN

NO

STORM INFRASTRUCTURE LOCATIONS DEPICTED ALONG HUNTER RD APPROXIMATED PER GARVER PLANS (HWY. 62 - CLYDE CARNES RD. (HWY. 170) (FARMINGTON) (S) WASHINGTON COUNTY F.A.P. STPU-9141(1) JOB 040683)

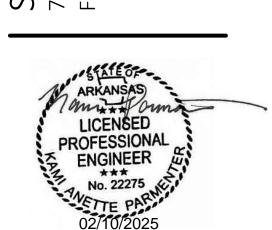



PROFESSIONAL OF RECORD	KAP
PROJECT MANAGER	EVD
DESIGNER	BWB
CEI PROJECT NUMBER	34338
DATE	2/10/2025
REVISION	REV-1

POST-DEVELOPMENT DRAINAGE MAP

SHEET NUMBER

25.1

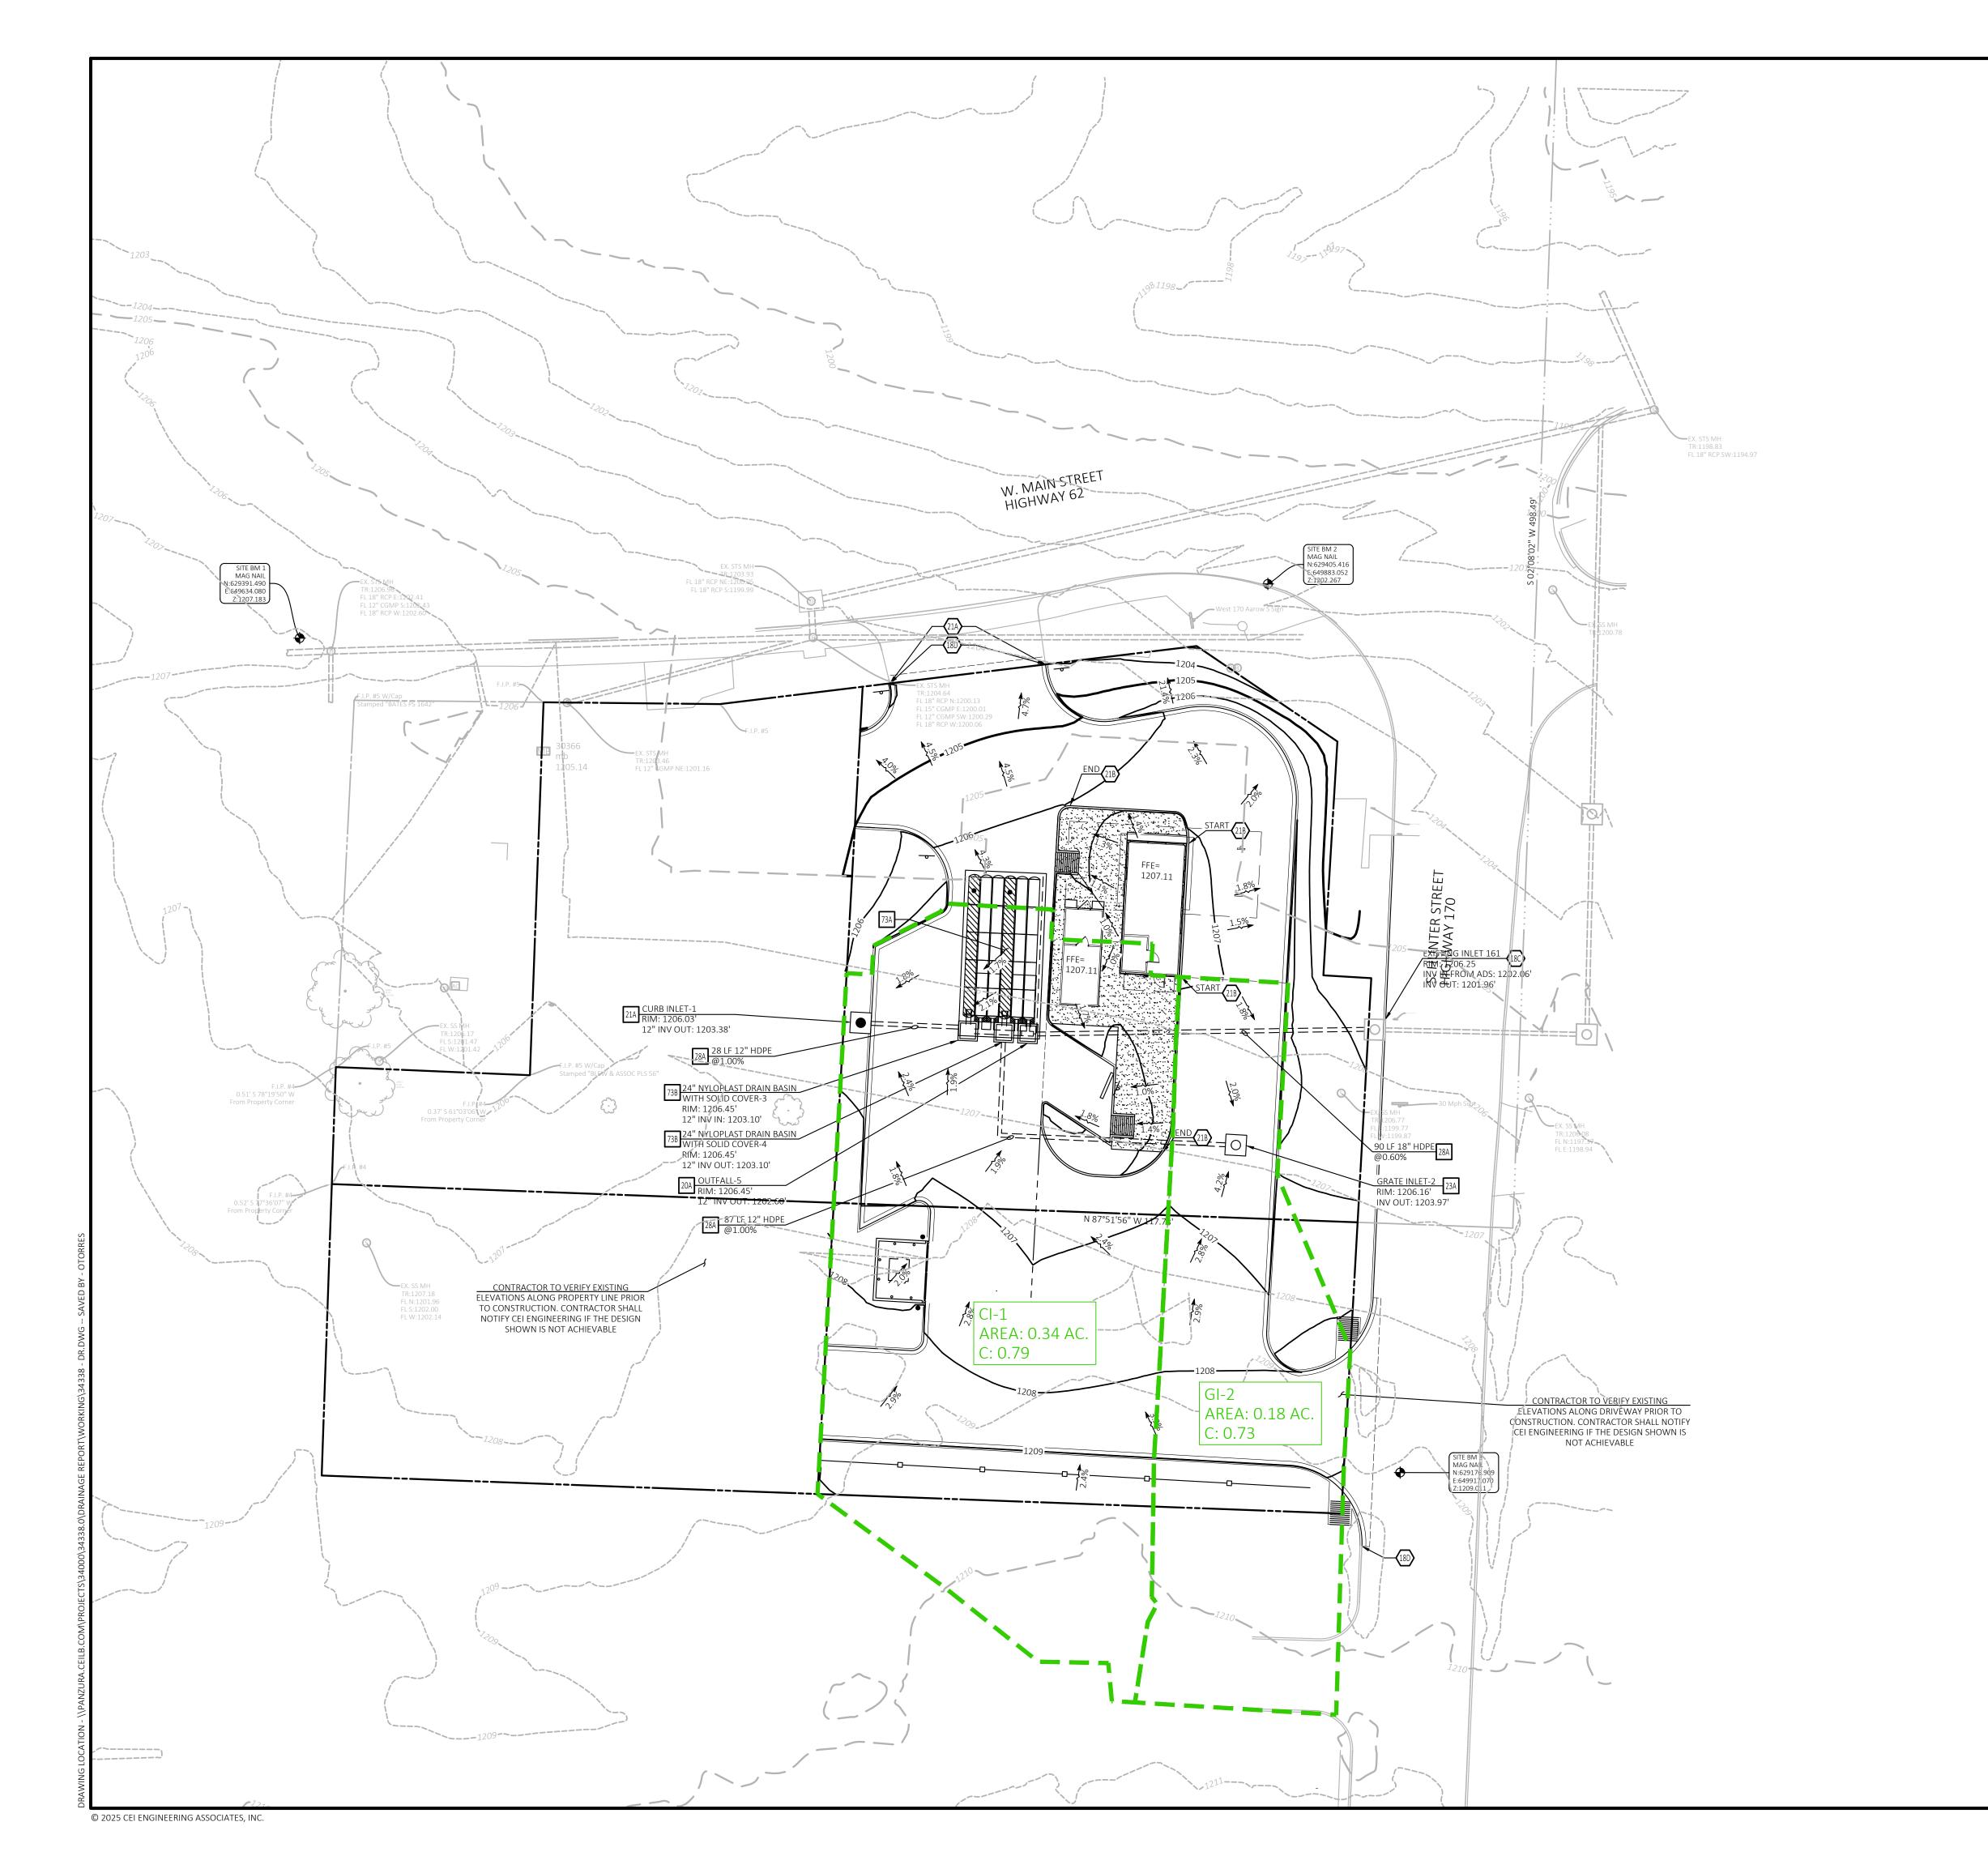

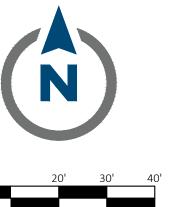



G GAS METER

GV GAS VALVE

GAS MARKER

OIL PIPELINE MARKER





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EB ELECTRIC BOX MB MAIL BOX TRAN ELEC. TRANSFORMER SIGN FLAG POLE E ELEC. MANHOLE EP ELEC. PEDESTAL FIRE HYDRANT EPB ELEC. PULL BOX WATER MANHOLE SPOT LIGHT WV WATER VALVE S SANITARY SEWER MANHOLE WATER METER SANITARY SEWER CLEANOUT DOWN SPOUT STORM SEWER MANHOLE AC AIR CONDITIONER T TELEPHONE RISER TRAFFIC SIGNAL TELEPHONE MANHOLE TSB TRAFFIC SIGNAL BOX TRAFFIC SIGNAL PULL BOX TELEPHONE MARKER PEDESTRIAN CROSSING SIGNAL TPB TELEPHONE PULL BOX GT GREASE TRAP FIBER OPTIC MARKER KEY PAD © COLUMN FOB FIBER OPTIC PULL BOX SECTION CORNER CT CABLE TV PEDESTAL QUARTER CORNER CABLE MARKER SET IRON PIN W/CAP CPB CABLE TV PULL BOX SET MAG NAIL W/WASHER SP IRRIGATION CONTROL VALVE FOUND MONUMENT SPRINKLER HEAD RIGHT OF WAY MARKER B BOLLARD DENT PIPE YARD HYDRANT/SPICKET FIRE DEPARTMENT CONNECT BENCHMARK PROPANE TANK ---- WATER LINE CHAIN LINK FENCE MASONRY FENCE TELEPHONE LINE FIBER OPTIC LINE E ELECTRIC LINE EASEMENT LINE SECTION LINE — X — BARBED WIRE FENCE S.I.P.-SET IRON PIN I.P.-IRON PIN CGMP-CORRUGATED METAL PIPE B/L/L-BUILDING LIMIT LINE F.I.P.-FOUND IRON PIN H/C-HANDICAP RCP-REINFORCED CONCRETE PIPE U/E-UTILITY EASEMENT NOTE: ALL MONUMENTS SET ARE CAPPED 1/2" IRON PINS OR MAG NAILS WITH WASHERS BOTH BEING STAMPED "DEE LS 1835"

PROPOSED LEGEND

EXISTING LEGEND

Ø POWER POLE


GUY ANCHOR

E ELECTRIC METER

LIGHT POLE


INLET DRAINAGE BASIN LIMITS CONTOUR ELEVATIONS ---- GRADE BREAK —— — — FLOWLINE ======= STORM DRAIN

STORM INFRASTRUCTURE LOCATIONS DEPICTED ALONG HUNTER RD APPROXIMATED PER GARVER PLANS (HWY. 62 - CLYDE CARNES RD. (HWY. 170) (FARMINGTON) (S) WASHINGTON COUNTY F.A.P. STPU-9141(1) JOB 040683)

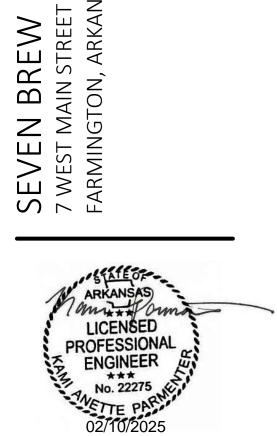

PROFESSIONAL OF RECORD	KAP
PROJECT MANAGER	EVD
DESIGNER	BWB
CEI PROJECT NUMBER	34338
DATE	2/10/2025
REVISION	REV-1

INLET MAP

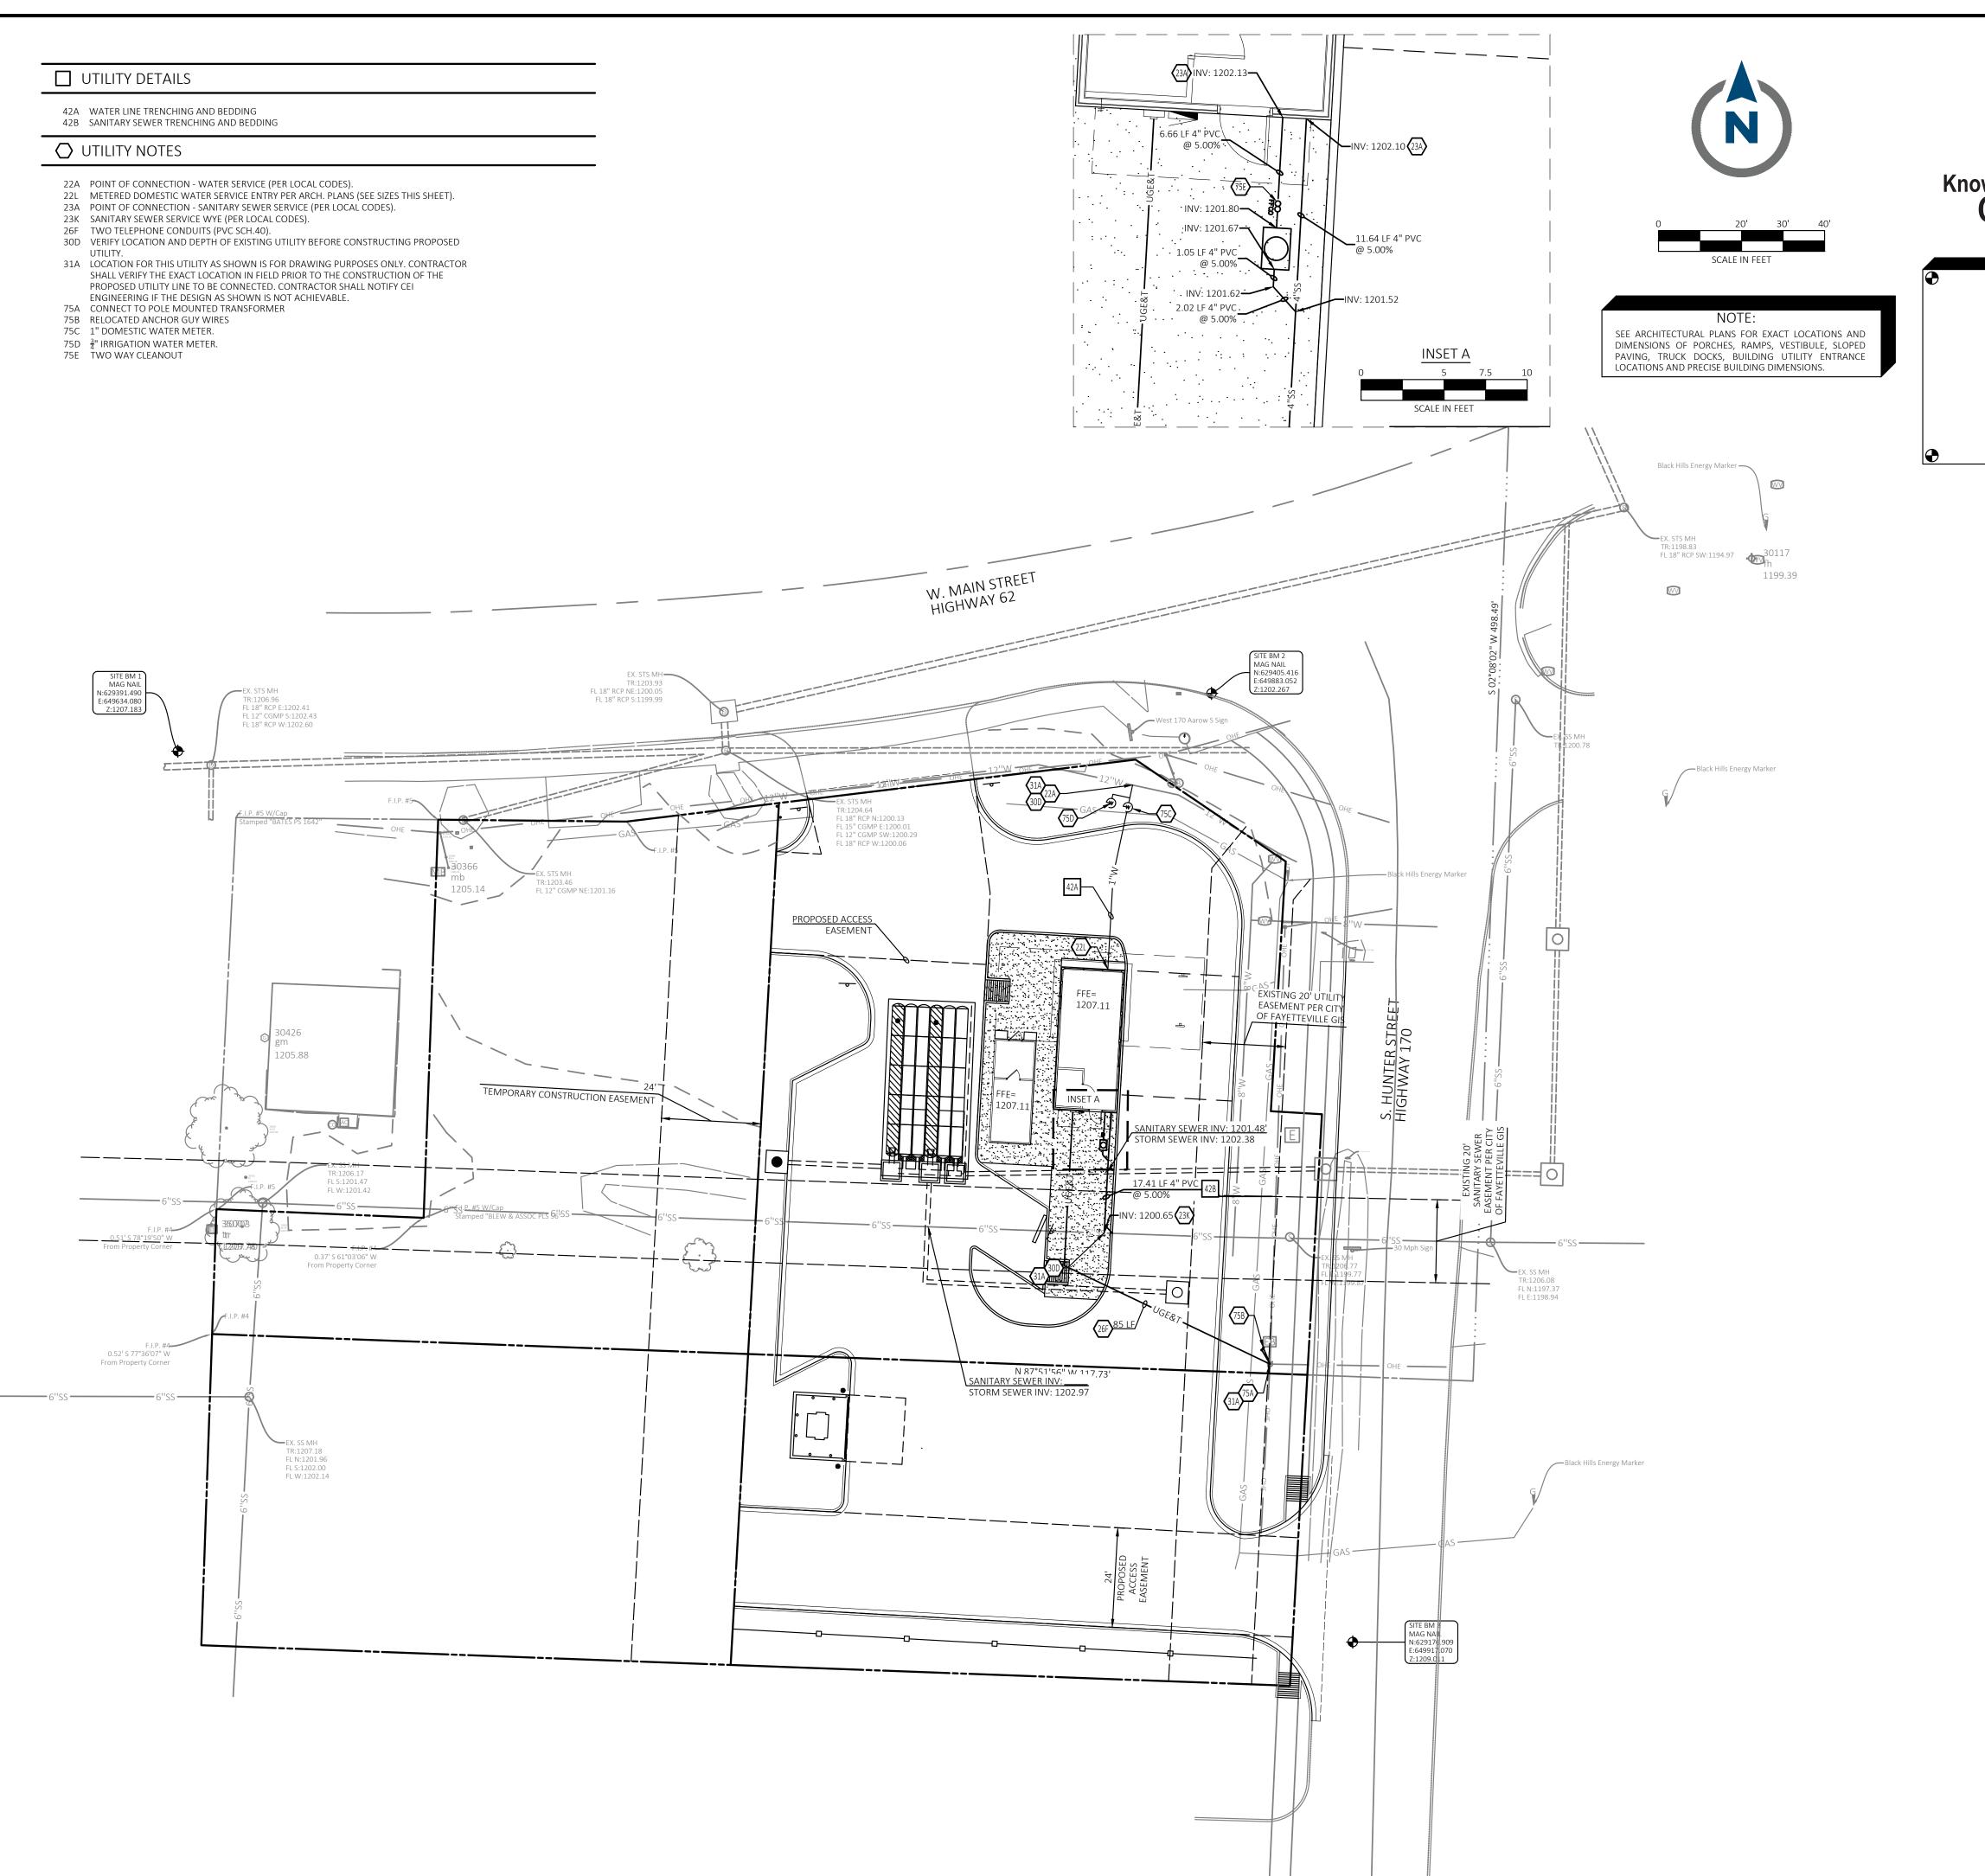



Know what's **below**. **Call** before you dig.

SITE BENCHMARK SITE BENCHMARK 1: MAG NAIL N: 629391.490 E: 649634.080 Z: 1207.183 SITE BENCHMARK 2: MAG NAIL N: 629405.416 E: 649883.052 Z: 1202.267

> SITE BENCHMARK 3: N: 629176.909

E: 649917.070 Z: 1209.011



VICINITY MAP NOT TO SCALE

LEGEND

G GAS METER

GV GAS VALVE

MB MAIL BOX

FIRE HYDRANT

WV WATER VALVE

DOWN SPOUT

TRAFFIC SIGNAL

GT GREASE TRAP

SECTION CORNER

QUARTER CORNER

SET IRON PIN W/CAP

FOUND MONUMENT

RW RIGHT OF WAY MARKER

(YH) YARD HYDRANT/SPICKET

—— // ——— WOOD PANEL FENCE

──

MASONRY FENCE

PROPERTY LINE

---- LOT LINE

⊕ BENCHMARK

SET MAG NAIL W/WASHER

AC AIR CONDITIONER

TSB TRAFFIC SIGNAL BOX TRAFFIC SIGNAL PULL BOX

PEDESTRIAN CROSSING SIGNAL

KEY PAD C COLUMN

WATER MANHOLE

SIGN FLAG POLE

GAS MARKER

OIL PIPELINE MARKER

EXISTING LEGEND



	JMENTS SET ARE CAPPED 1/2" IRON PINS BOTH BEING STAMPED "DEE LS 1835"	OR MAG NAILS	
PROPOSED LEG	GEND		
	PROPERTY LINE/RIGHT OF WAY LINE	•	CURB INLET
======	STORM DRAIN	0	GRATE INLET
— UGE&T——	UNDERGROUND ELECTRIC AND TELEPHONE SERVICE		GREASE TRAP (PER SEVEN BREW STANDARDS)
—— X"SS ——	SANITARY SEWER SERVICE	\sim	DOUBLE CLEANOUT
—— X''W ——	WATER SERVICE	FFC0	DOODLE CLEANIOUT

S.I.P.-SET IRON PIN I.P.-IRON PIN CGMP-CORRUGATED METAL PIPE B/L/L-BUILDING LIMIT LINE F.I.P.-FOUND IRON PIN H/C-HANDICAP RCP-REINFORCED CONCRETE PIPE U/E-UTILITY EASEMENT

GENERAL UTILITY NOTES

- A. ALL WATER LINES SHALL BE "TYPE K" WITH 36" MIN. COVER.
- B. ALL SANITARY SEWER LINES SHALL BE SDR 35 WITH 36" MIN. COVER.
- C. CONTRACTOR SHALL COORDINATE ANY DISRUPTIONS TO EXISTING UTILITY SERVICES WITH ADJACENT PROPERTY
- D. ALL ELECTRIC, TELEPHONE AND GAS EXTENSIONS INCLUDING SERVICE LINES SHALL BE CONSTRUCTED TO THE APPROPRIATE UTILITY COMPANY SPECIFICATIONS. ALL UTILITY DISCONNECTIONS SHALL BE COORDINATED WITH THE DESIGNATED UTILITY COMPANIES.
- E. CONSTRUCTION SHALL NOT START ON ANY PUBLIC UTILITY SYSTEM UNTIL WRITTEN APPROVAL HAS BEEN RECEIVED BY THE ENGINEER FROM THE APPROPRIATE GOVERNING AUTHORITY AND CONTRACTOR HAS BEEN NOTIFIED BY THE
- F. PRIOR TO THE CONSTRUCTION OF OR CONNECTION TO ANY STORM DRAIN, SANITARY SEWER, WATER MAIN OR ANY OF THE DRY UTILITIES, THE CONTRACTOR SHALL EXCAVATE, VERIFY AND CALCULATE ALL POINTS OF CONNECTION AND ALL UTILITY CROSSINGS AND INFORM CEI ENGINEERING AND THE OWNER/DEVELOPER OF ANY CONFLICT OR REQUIRED DEVIATIONS FROM THE PLAN. NOTIFICATION SHALL BE MADE A MINIMUM OF 48 HOURS PRIOR TO CONSTRUCTION. CEI ENGINEERING AND ITS CLIENTS SHALL BE HELD HARMLESS IN THE EVENT THAT THE CONTRACTOR FAILS TO MAKE SUCH NOTIFICATION.
- G. UNLESS OTHERWISE SHOWN, CALLED OUT OR SPECIFIED HEREON OR WITHIN SPECIFICATIONS: ALL WATER LINE PIPE BEDDING SHALL BE INSTALLED PER DETAIL 42A. ALL SANITARY SEWER PIPE BEDDING SHALL BE INSTALLED PER DETAIL
- H. PRIOR TO ANY CONSTRUCTION IN RIGHT-OF-WAY, CONTRACTOR SHALL INSTALL TRAFFIC CONTROL IN ACCORDANCE WITH MUTCD.

Land and Life

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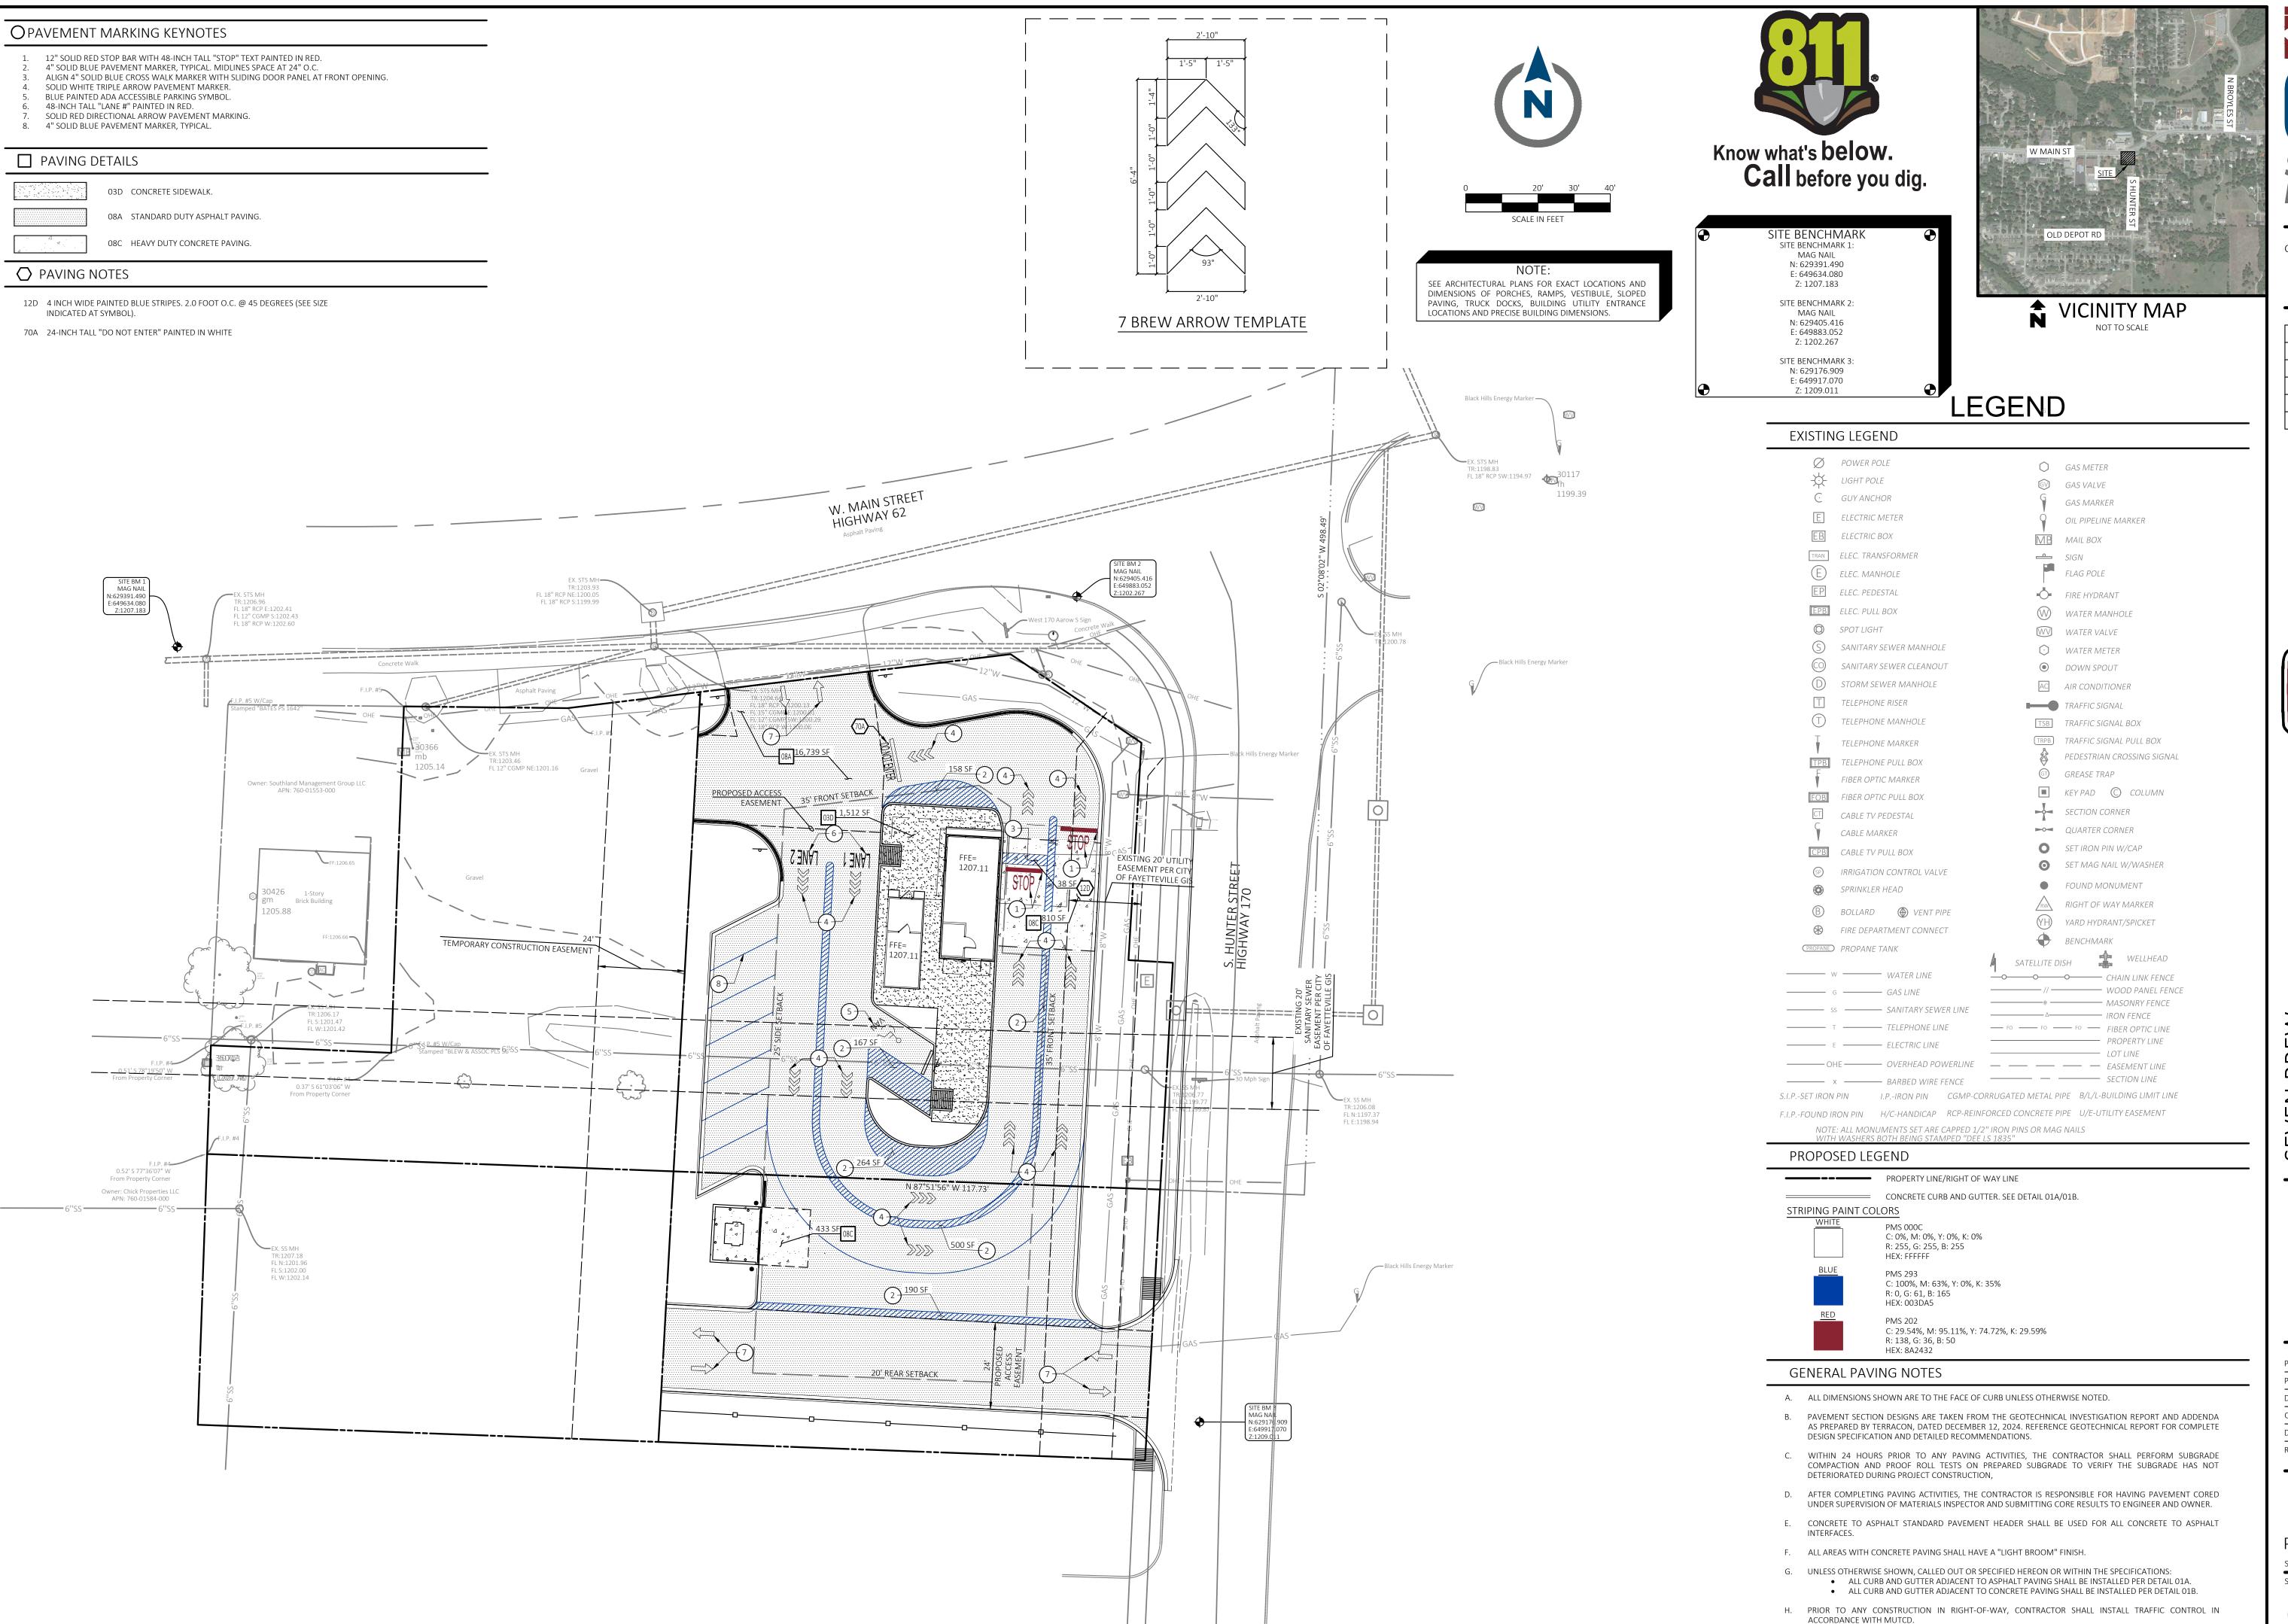
	REVISION		
10.	DESCRIPTION	DATE	





PROFESSIONAL OF RECORD	KAI
PROJECT MANAGER	EVD
DESIGNER	BWE
CEI PROJECT NUMBER	34338
DATE	2/10/2025
REVISION	REV-1

UTILITY PLAN




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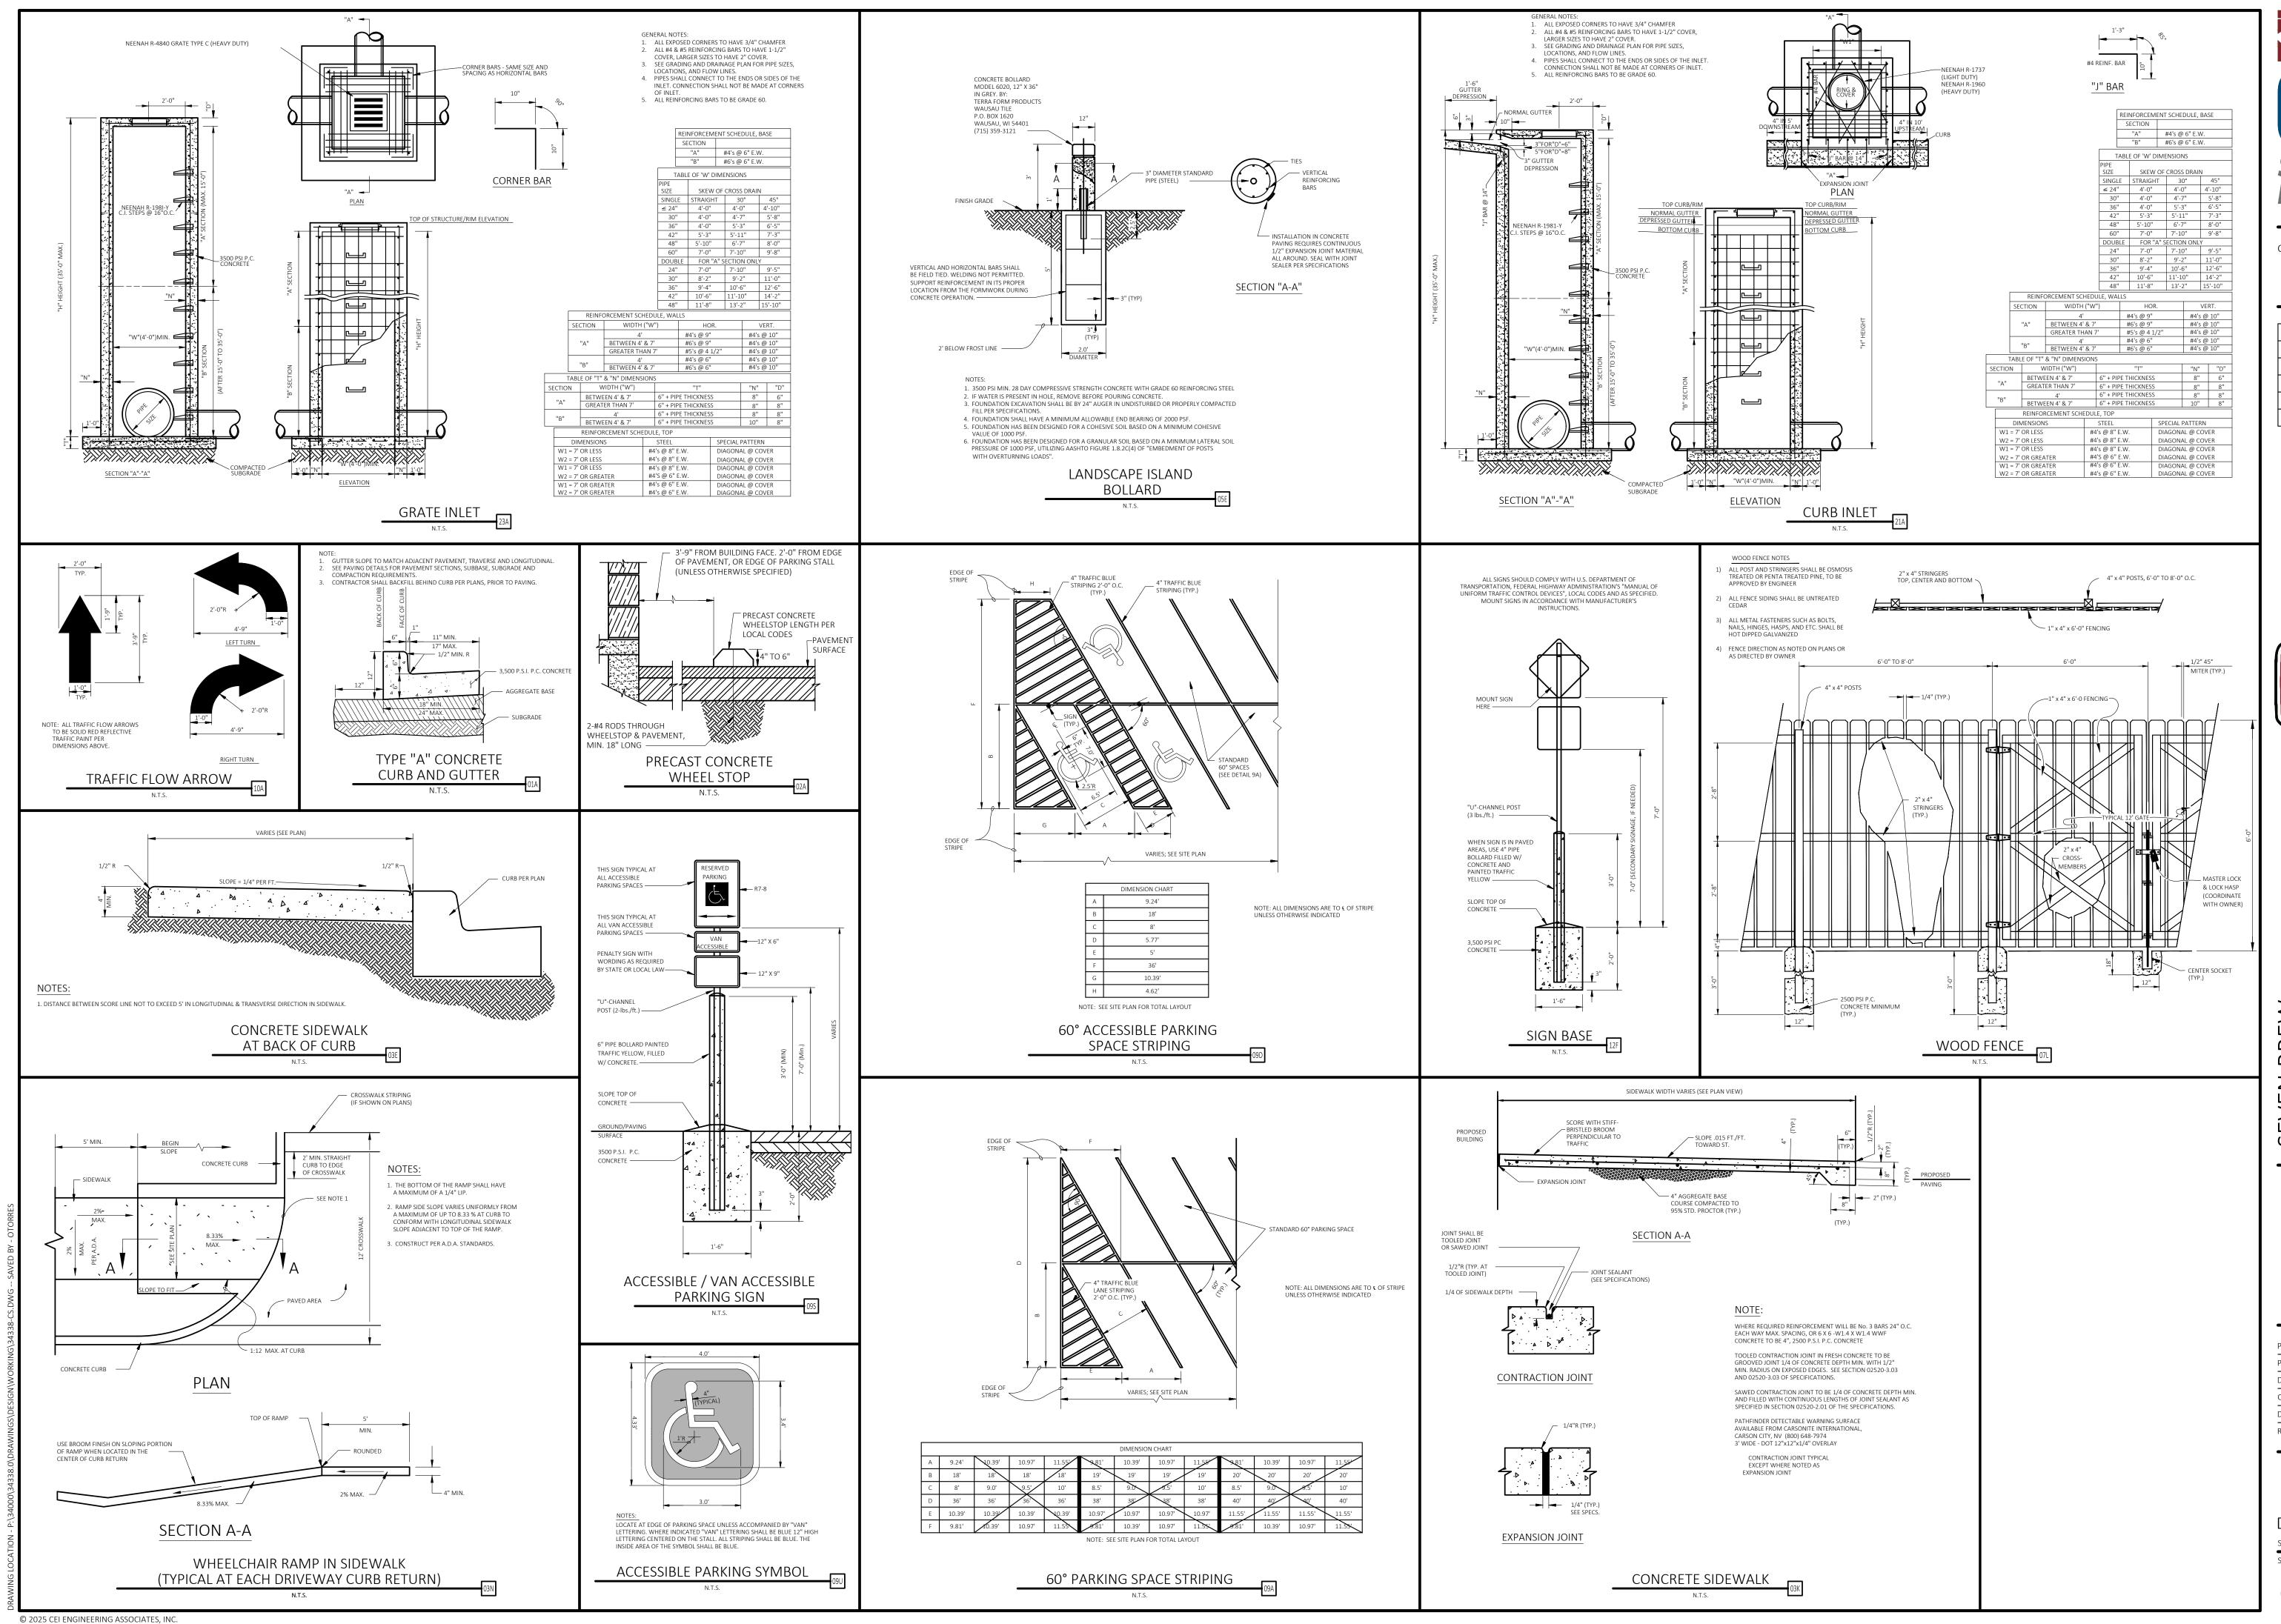


VEN BREVEST MAIN STAMINGTON, A S ~ 7



PROFESSIONAL OF RECORD	KAF
PROJECT MANAGER	EVD
DESIGNER	BWE
CEI PROJECT NUMBER	34338
DATE	2/10/2025
REVISION	REV-1

PAVING PLAN

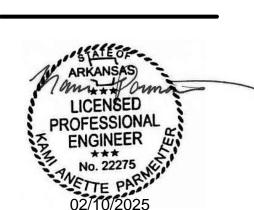




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BENTONVILLE, AR 72712
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FAX: (479) 273-0844

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NO.	DESCRIPTION	DATE



SEVEN BREW
7 WEST MAIN STREET
FARMINGTON, ARKANSA

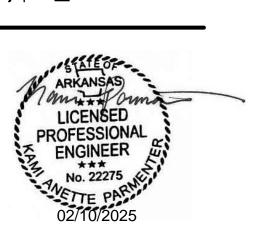


PROFESSIONAL OF RECORD	KAP
PROJECT MANAGER	EVD
DESIGNER	BWB
CEI PROJECT NUMBER	34338
DATE	2/10/2025
REVISION	REV-1

DETAIL SHEET I

SHEET NUMBER

C8.0

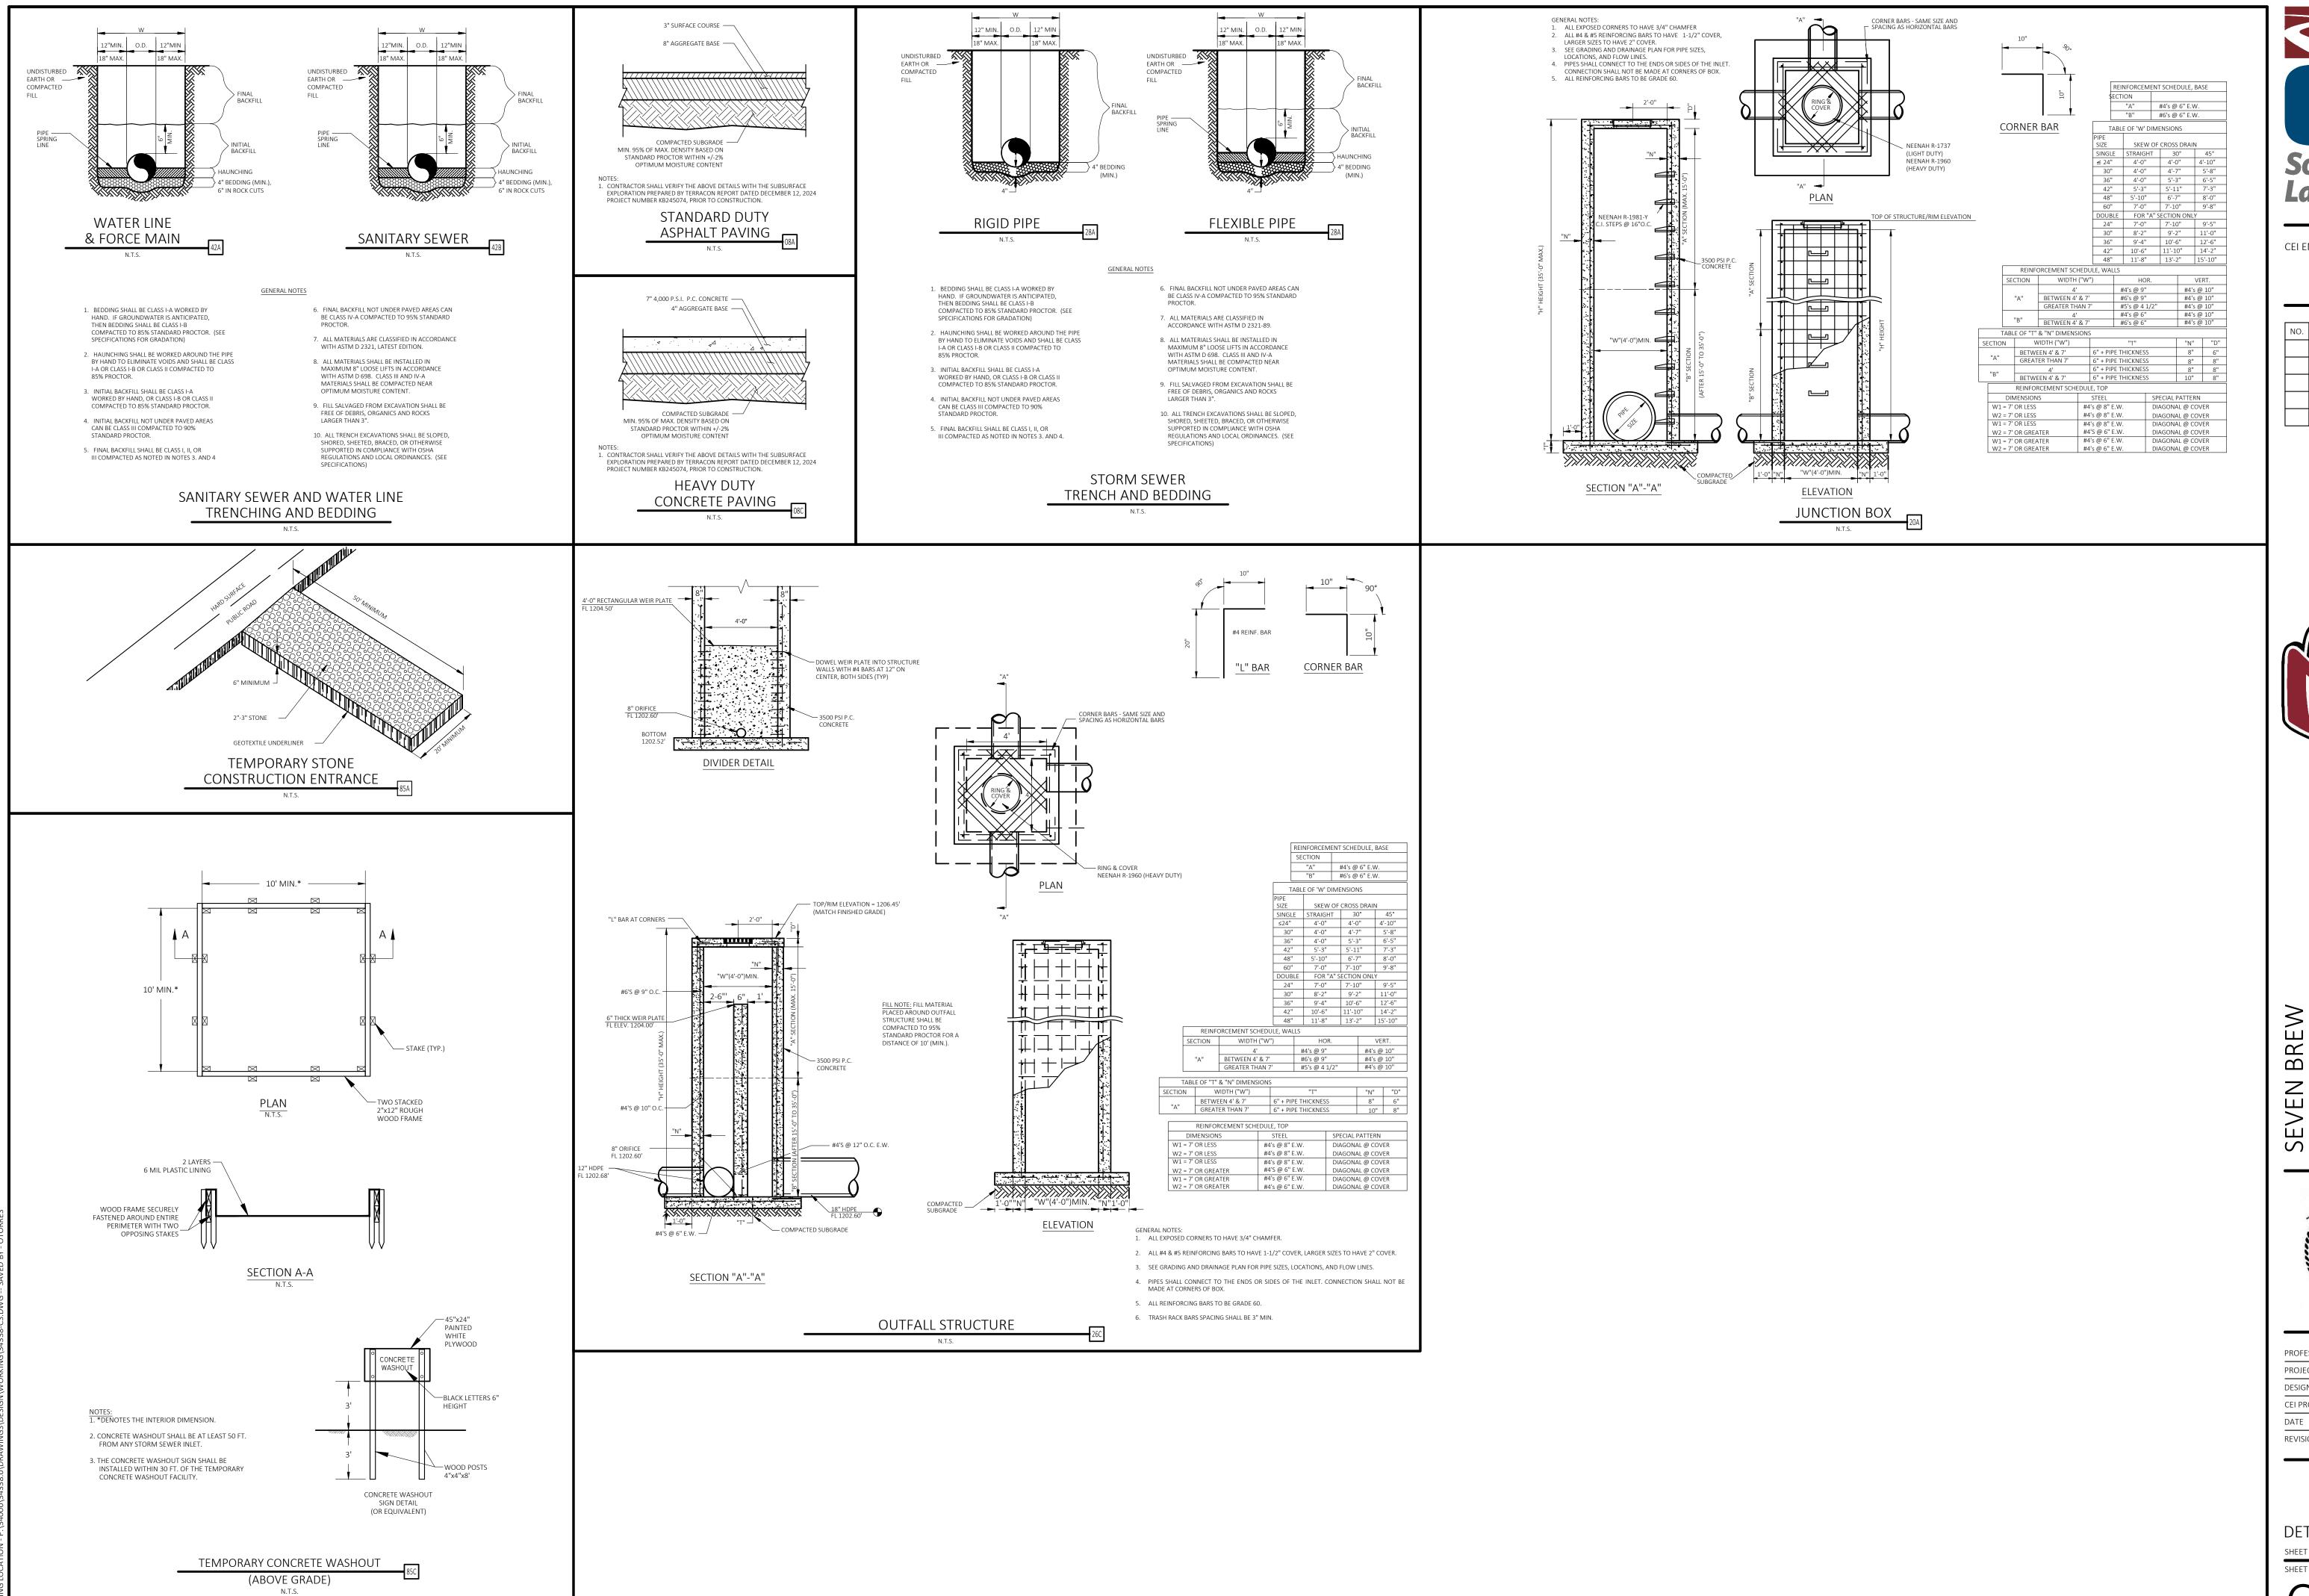




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	REVISION	
NO.	DESCRIPTION	DATE



SEVEN BREW
7 WEST MAIN STREET
FARMINGTON, ARKANS

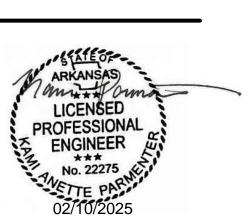

PROFESSIONAL OF RECORD	КАР
PROJECT MANAGER	EVD
DESIGNER	BWB
CEI PROJECT NUMBER	34338
DATE	2/10/2025
REVISION	REV-1

DETAIL SHEET I


SHEET NUMBER

C8.1


BEST MANAGEMENT PRACTICES (BMPs)


POLLUTION THROUGH STORM RUNOFF IS INTENSIFIED AT CONSTRUCTION SITES DUE TO THE REMOVAL OF THE NATURAL GROUND COVER OF THE SITE, AS WELL AS THE INTRODUCTION OF HAZARDOUS CHEMICALS AND WASTES TO THE AREA. MEASURES ARE REQUIRED, BOTH DURING CONSTRUCTION AND AFTER THE COMPLETION OF CONSTRUCTION, TO STABILIZE THE SITE. STABILIZATION OF THE SITE DURING CONSTRUCTION ACTIVITIES CONSISTS OF THE INSTALLATION OF TEMPORARY OR PERMANENT MEASURES TO PREVENT EROSION, OR TO INTÉRCEPT SEDIMENT PRIOR TO IT LEAVING THE SITE. THIS CAN BE ACCOMPLISHED THROUGH THE USE OF GROUND COVER MULCHING, PAVING, SILT FENCES, AND SEDIMENT BASINS, ALONG WITH CONSTRUCTION METHODS, TO REDUCE THE DISTURBED AREAS OF CONSTRUCTION.

ALL WORK CONSISTS OF FURNISHING, INSTALLING, MAINTAINING, AND, WHEN REQUIRED, REMOVING EROSION CONTROL DEVICES.

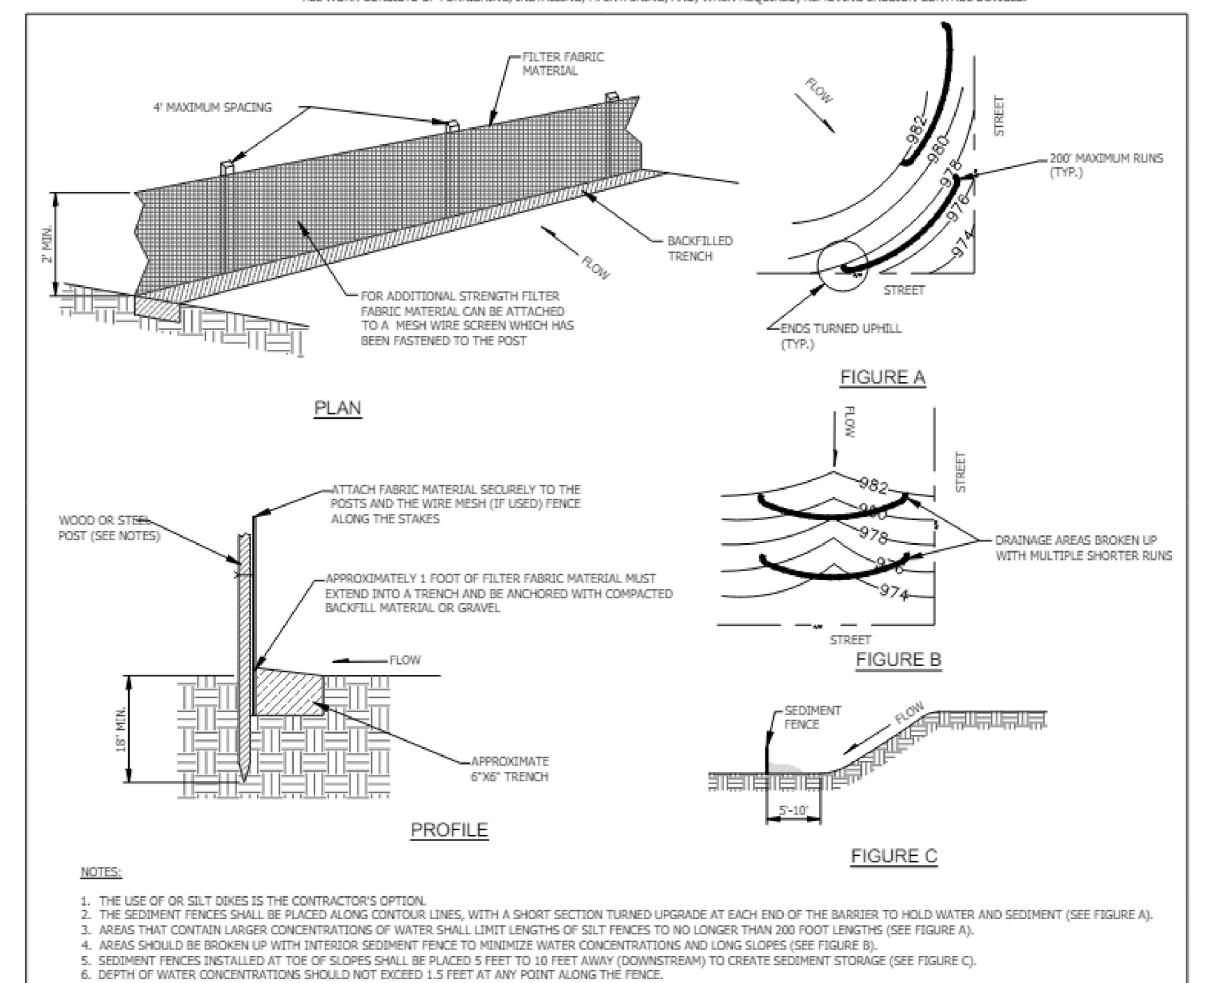



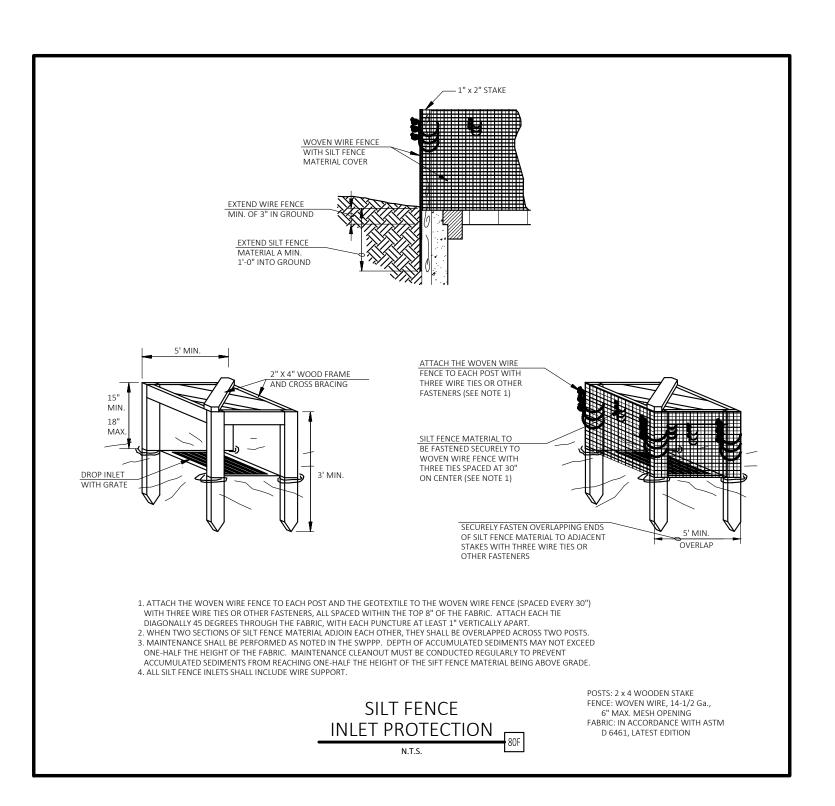

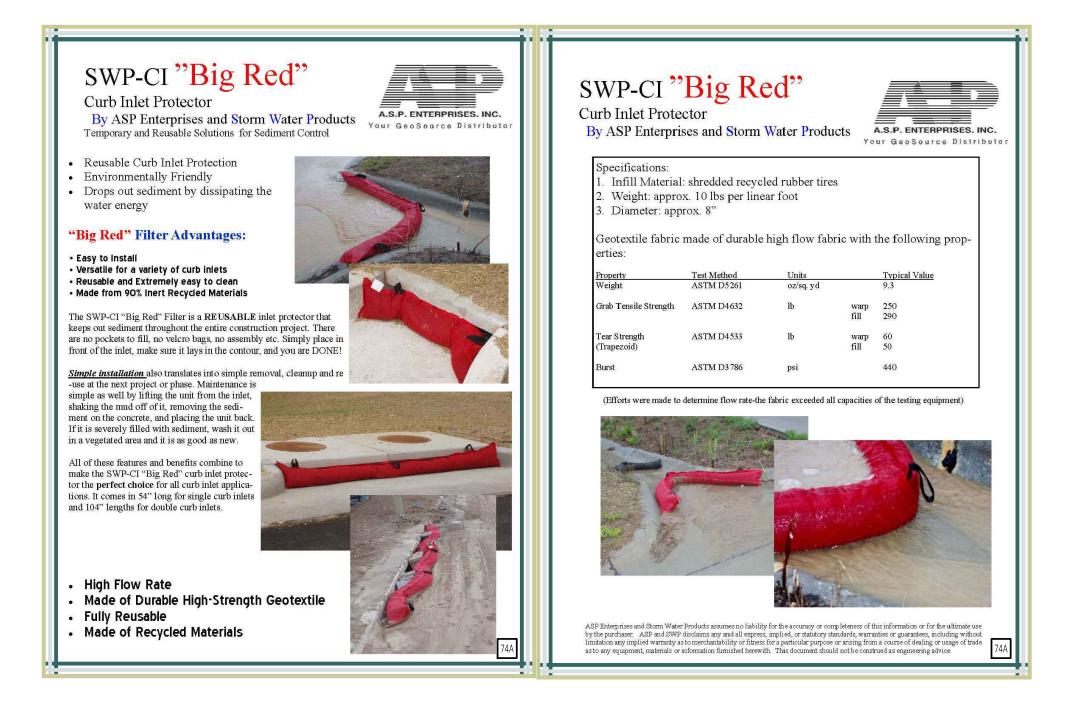



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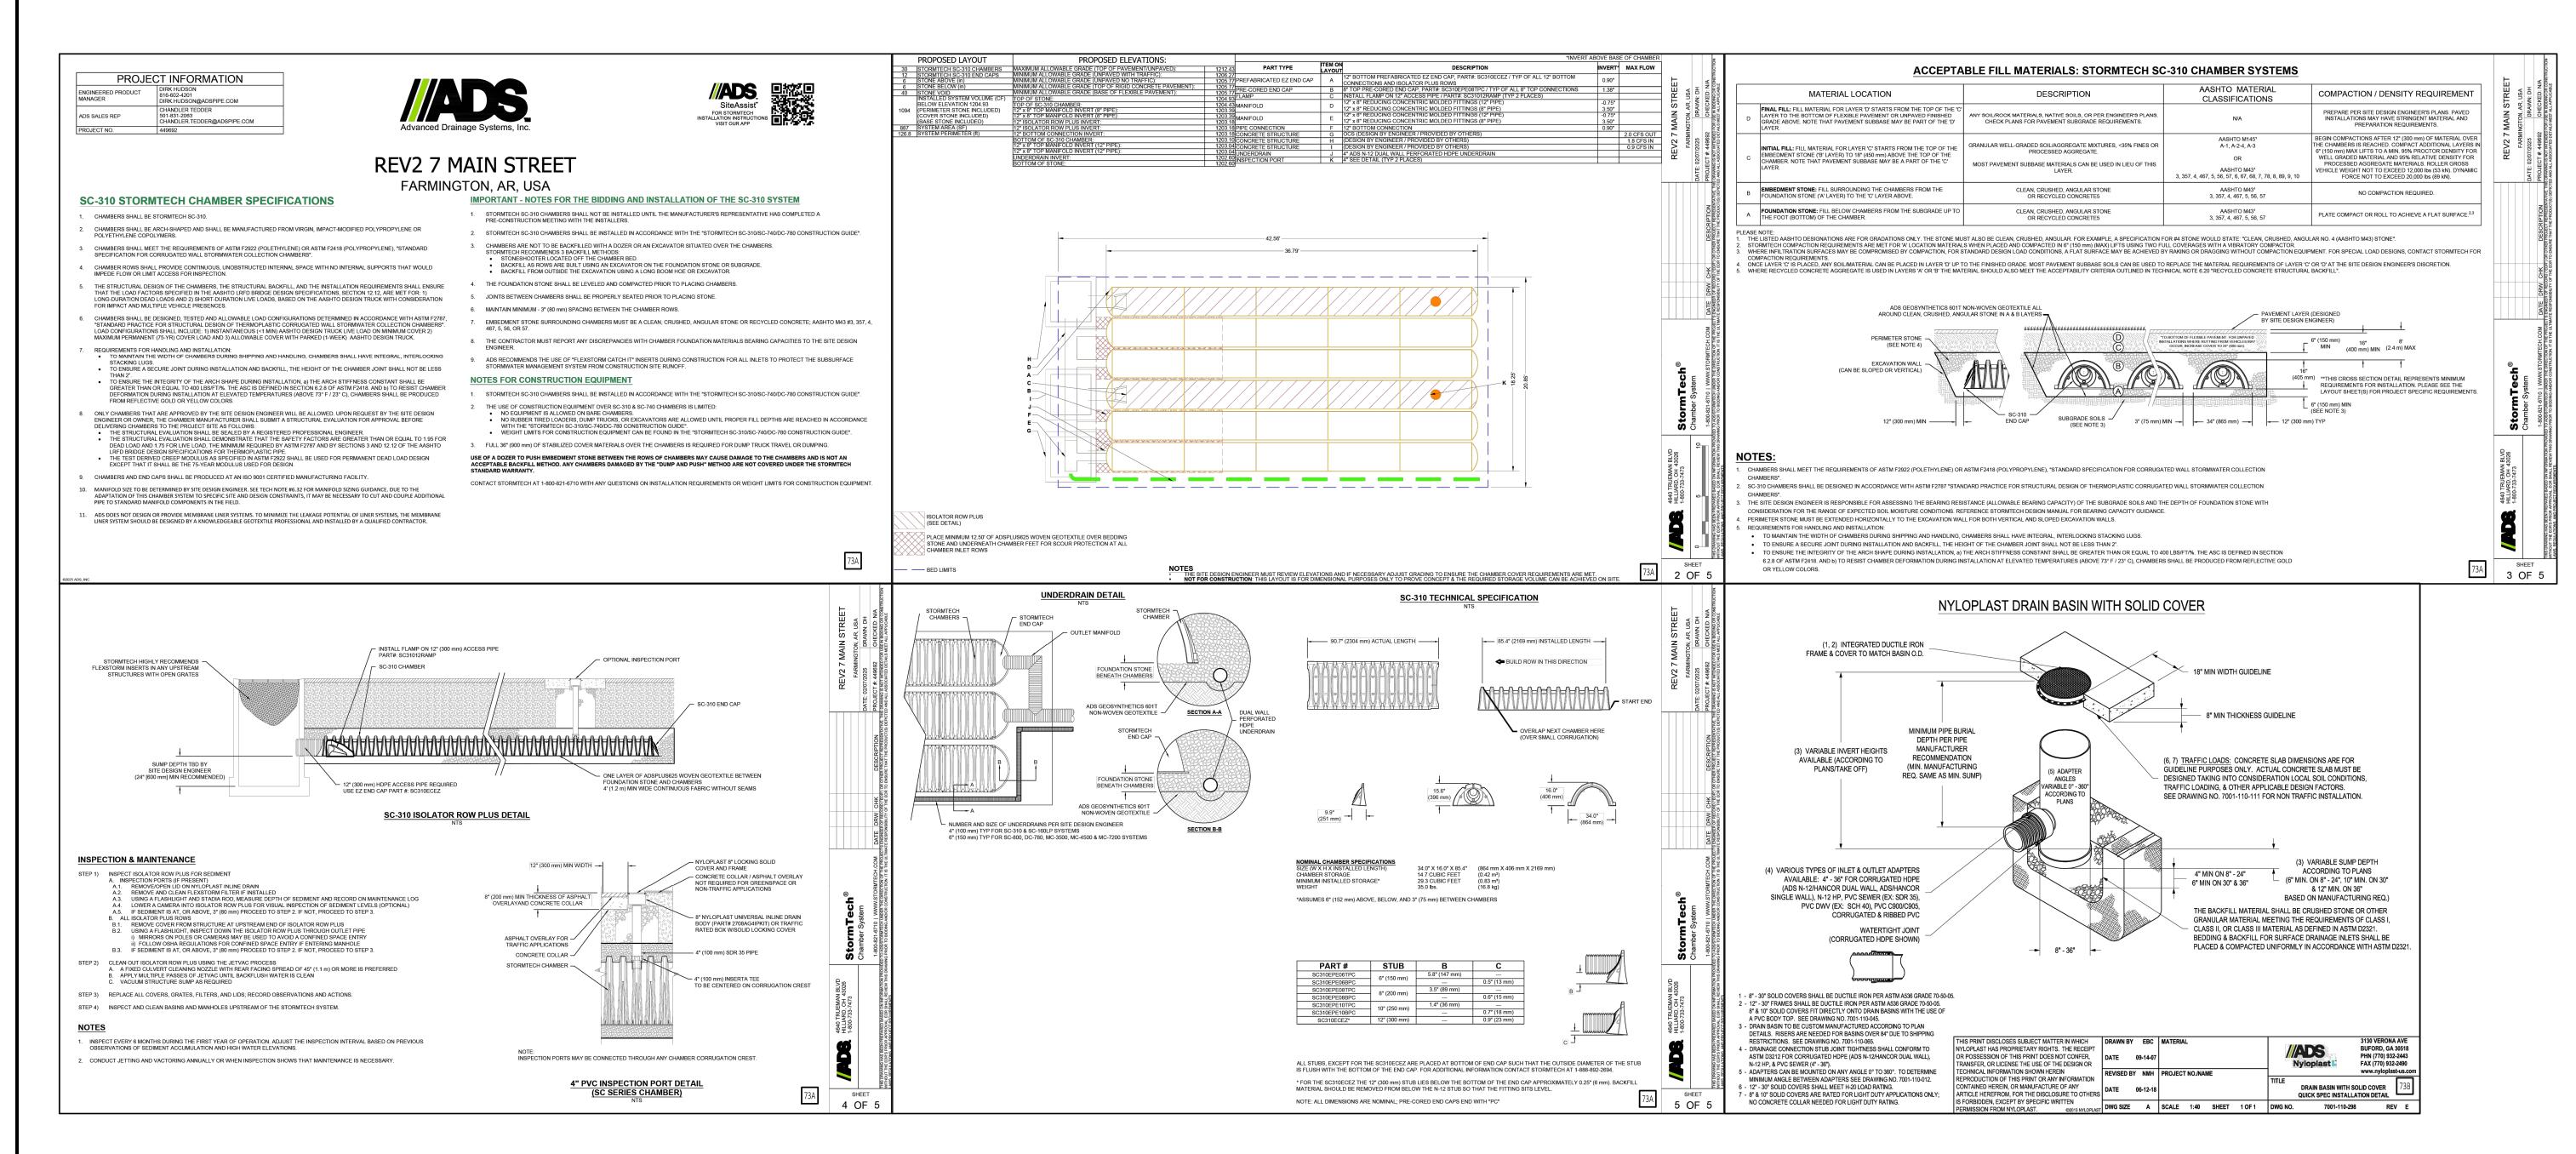
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NO.	DESCRIPTION	DATE






PROFESSIONAL OF RECORD	KAP
PROJECT MANAGER	EVD
DESIGNER	BWB
CEI PROJECT NUMBER	34338
DATE	2/10/2025
REVISION	REV-1

DETAIL SHEET II



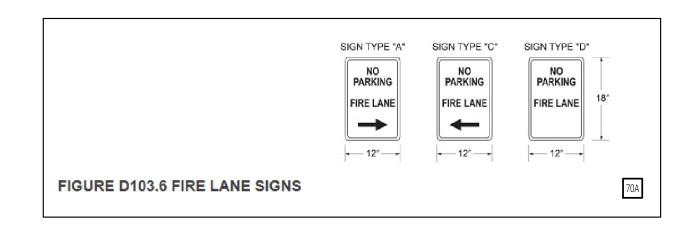


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	REVISION		•
IO.	DESCRIPTION	DATE	



SEVEN BREW
7 WEST MAIN STREET
FARMINGTON, ARKANSAS



PROFESSIONAL OF RECORD	KAP
PROJECT MANAGER	EVD
DESIGNER	BWB
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DETAIL SHEET IV
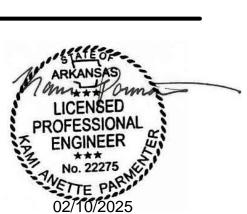
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