# BRAND NEW CHURCH FARMINGTON, ÅRKANSAS

LARGE SCALE DEVELOPMENT PLANS

### GENERAL NOTES TO CONTRACTOR

- THE CONTRACTOR IS SPECIFICALLY CAUTIONED THAT THE LOCATION AND/OR ELEVATION OF EXISTING UTILITIES AS SHOWN ON THESE PLANS IS BASED ON RECORDS OF THE VARIOUS UTILITY COMPANIES, AND WHERE POSSIBLE, MEASUREMENTS TAKEN IN THE FIELD. THE INFORMATION IS NOT TO BE RELIED ON AS BEING EXACT OR COMPLETE. THE CONTRACTOR MUST CONTACT THE APPROPRIATE UTILITY COMPANIES AT LEAST 72 HOURS BEFORE ANY EXCAVATION TO REQUEST EXACT FIELD LOCATION OF UTILITIES. IT SHALL BE THE CONTRACTOR'S RESPONSIBILITY TO RELOCATE UTILITIES WHICH CONFLICT WITH THE PROPOSED IMPROVEMENTS SHOWN ON THE PLANS.
- 2. CONTRACTOR SHALL VERIFY HORIZONTAL AND VERTICAL LOCATION OF ALL EXISTING UTILITIES PRIOR TO STARTING CONSTRUCTION.
- 3. EXISTING GRADE CONTOURS ARE AT ONE FOOT INTERVALS.
- 4. PROPOSED CONTOURS ARE AT FINISH GRADE AND ARE AT ONE FOOT INTERVALS
- 5. PROPOSED SPOT ELEVATIONS ARE TOP OF FINISH CURB UNLESS OTHERWISE INDICATED OR SHOWN.
- 6. THE CONTRACTOR SHALL ADHERE TO ALL TERMS AND CONDITIONS AS OUTLINED IN THE STORMWATER POLLUTION PREVENTION PLAN.
- CONTRACTOR TO INSTALL MUD ABATEMENT ENTRANCES ANYWHERE PROPOSED STREETS ENTER EXISTING PUBLIC STREETS. ENTRANCE TO BE CONSTRUCTED A MIN. OF 50' IN LENGTH BY WIDTH OF PROPOSED STREET AND TO A DEPTH OF 8 INCHES.
- CONTRACTOR TO INSTALL EROSION CONTROL FENCING PRIOR TO BEGINNING ANY CONSTRUCTION. FENCING SHALL BE MAINTAINED & REPAIRED AS NECESSARY BY THE CONTRACTOR DURING CONSTRUCTION
- 9. CONTRACTOR SHALL ASSURE POSITIVE DRAINAGE AWAY FROM BUILDINGS FOR ALL NATURAL AND PAVED AREAS.
- 10. CONTRACTOR SHALL ADJUST AND/OR NEATLY CUT EXISTING PAVEMENT TO ASSURE A SMOOTH FIT AND TRANSITION.
- 11. ALL CONCRETE TO HAVE A MINIMUM 28 DAY COMPRESSION STRENGTH OF 3500 PSI.
- 12. DAMAGE DURING CONSTRUCTION TO ANY EXISTING STRUCTURES TO REMAIN SHALL BE THE CONTRACTOR'S RESPONSIBILITY TO REPAIR AND/OR REPLACE.
- 13. ALL MATERIALS AND CONSTRUCTION NOT UNDER THE JURISDICTION OF THE CITY OF FAYETTEVILLE OR WASHINGTON WATER AUTHORITY SHALL COMPLY WITH THE CITY OF FARMINGTON'S REQUIREMENTS. IN THE CASE OF CONFLICTS, THE CITY'S CRITERIA SHALL GOVERN.
- 14. ALL SIDEWALKS AND HANDICAP RAMPS SHALL BE BUILT TO THE CURRENT STANDARDS OF THE AMERICANS WITH DISABILITIES ACT REQUIREMENTS.
- 15. THE CITY OF FAYETTEVILLE WILL BE REVIEWING THIS PROJECT FOR WATER AND SEWER SERVICE AS IT IS LOCATED WITHIN THE JURISDICTION OF THE CITY OF FAYETTEVILLE PER OUR RECORDS.
- 16. SANITARY SEWER SYSTEM MUST BE INSTALLED, INSPECTED, TESTED, AND CERTIFIED PER ALL CITY OF FAYETTEVILLE STANDARD SPECIFICATIONS FOR INSTALLATION OF SEWER LINES.
- 17. NO WORK ON THE SEWER-LINES SHOULD TAKE PLACE UNTIL PLANS ARE APPROVED, MATERIAL SUBMITTALS ARE REVIEWED AND APPROVED, AND A PRECONSTRUCTION CONFERENCE HAS OCCURRED AT THE CITY OF FAYETTEVILLE.
- 18. THIS PROJET MUST MEET OR EXCEED THE CITY OF FAYETTEVILLE, ARKANSAS STANDARD SPECIFICATIONS FOR DESIGN AND CONSTRUCTION OF WATER LINES AND SEWER LINES, 2017 EDITION.

REVIEW OF THESE PLANS IS LIMITED TO GENERAL COMPLIANCE WITH CITY CODES AND REGULATIONS AND DOES NOT WARRANT THE ENGINEER'S DESIGN OR RELIEVE THE DEVELOPER OF ANY REQUIREMENTS, EVEN IF ERRORS, OMISSIONS, OR ANY INADEQUACIES ARE DISCOVERED AFTER PLAN APPROVAL. THE CITY'S REQUIREMENTS SHALL GOVERN OVER ANY CONFLICTS WITH THE PLANS OR SPECIFICATIONS. ANY CONDITIONS DETERMINED IN THE FIELD WHICH REQUIRE CHANGES SHALL BE SUBJECT TO FURTHER REVIEW AND CORRECTIVE ACTION.

#### THERE ARE NO EXISTING WETLANDS ON THIS SITE.

#### FLOOD CERTIFICATION:

NO PORTION OF THIS PROPERTY IS LOCATED WITHIN FLOOD ZONE "A" OR "AE" AS DETERMINED BY THE NATIONAL FLOOD INSURANCE PROGRAM FLOOD INSURANCE RATE MAP FOR WASHINGTON COUNTY, ARKANSAS. (FIRM PANEL #05143C0195F. DATED 05/16/2008)

#### OWNERSHIP OF DOCUMENTS

THIS DOCUMENT, AND THE IDEAS AND DESIGNS INCORPORATED HEREIN, AS AN INSTRUMENT OF PROFESSIONAL SERVICES, IS THE PROPERTY OF BATES + ASSOCIATES, INC., AND IS NOT TO BE USED, IN WHOLE OR PART, FOR ANY OTHER PROJECT WITHOUT THE WRITTEN AUTHORIZATION OF BATES + ASSOCIATES, INC.

#### SAFETY NOTICE TO CONTRACTOR


IN ACCORDANCE WITH GENERALLY ACCEPTED CONSTRUCTION PRACTICES, THE CONTRACTOR WILL BE SOLELY AND COMPLETELY RESPONSIBLE FOR CONDITIONS OF THE JOB SITE. INCLUDING SAFETY OF ALL PERSONS AND PROPERTY DURING PERFORMANCE OF THE WORK. THIS REQUIREMENT WILL APPLY CONTINUOUSLY AND NOT BE LIMITED TO NORMAL WORKING

THE DUTY OF THE ENGINEER TO CONDUCT CONSTRUCTION REVIEW OF THE CONTRACTOR'S PERFORMANCE IS NOT INTENDED TO INCLUDE REVIEW OF THE ADEQUACY OF THE CONTRACTOR'S SAFETY MEASURES, IN, OR NEAR THE CONSTRUCTION SITE.



#### ENGINEER'S NOTICE TO CONTRACTOR


THE EXISTENCE AND LOCATION OF ANY UNDERGROUND UTILITY PIPES OR STRUCTURES SHOWN ON THESE DRAWINGS ARE OBTAINED BY A SEARCH OF THE AVAILABLE RECORDS. TO THE BEST OF OUR KNOWLEDGE THERE ARE NO EXISTING UTILITIES EXCEPT AS SHOWN ON THESE DRAWINGS AND WE ASSUME NO RESPONSIBILITY AS TO THE ACCURACY OF THEIR DEPICTED LOCATION ON THESE DRAWINGS. THE CONTRACTOR IS REQUIRED TO TAKE DUE PRECAUTIONARY MEASURES TO PROTECT THE UTILITY LINES SHOWN, AND ALL OTHER LINES NOT OF RECORD OR NOT SHOWN ON THESE DRAWINGS BY VERIFICATION OF THEIR LOCATION IN THE FIELD PRIOR TO THE INITIATION OF THE ACTUAL PORTION OF THEIR WORK.

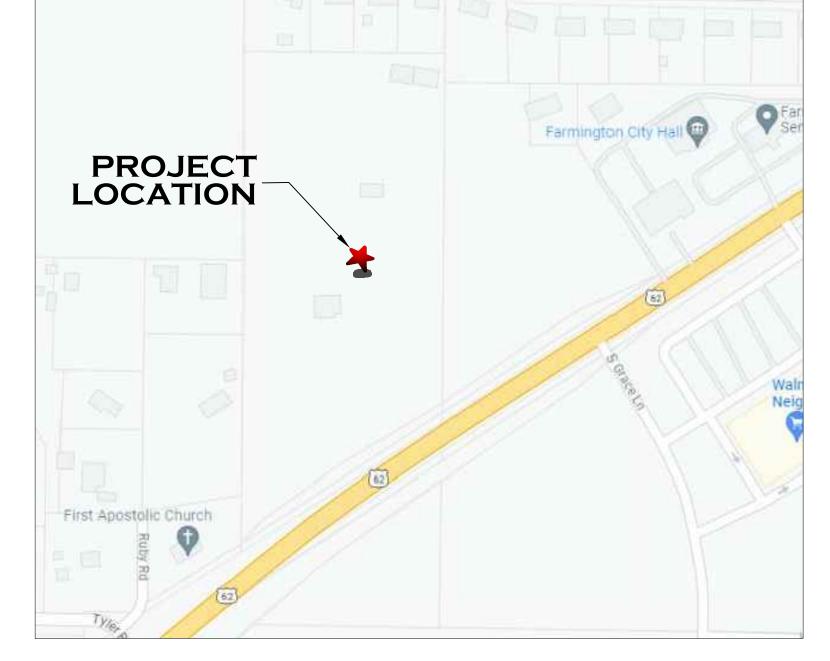

BASIS OF OBSERVATION GPS OBSERVATION - AR NORTH ZONE





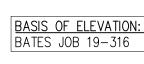

A PART OF THE SOUTHEAST QUARTER OF THE NORTHWEST QUARER OF SECTION 27, TOWNSHIP 16 NORTH, RANGE 31 WEST, WASHINGTON COUNTY, ARKANSAS, BEING MORE PARTICULARLY DESCRIBED AS FOLLOWS, TO-WIT: BEGINNING AT AN EXISTING ROD WHICH IS S02°50'42"W 150.15' FROM A CONCRETE MONUMENT MARKING THE NORTHEAST CORNER OF SAID FORTY ACRE TRACT AND RUNNING THENCE S02°21'21"W 713.69' TO AN EXISTING ALUMINUM MONUMENT ON THE NORTH RIGHT-OF-WAY OF U.S. HIGHWAY #62, THENCE ALONG SAID RIGHT-OF-WAY THE FOLLOWING: S60°28'58"W 245.70' TO AN EXISTING ALUMINUM | MONUMENT, S55°59'50"W 205.43', S42°06'22"W 51.69', THENCE LEAVING SAID RIGHT-OF-WAY NO2°12'34"E 1001.95' TO AN EXISTING ROD, THENCE S88°03'52"E 409.71' TO THE POINT OF BEGINNING, CONTAINING 7.93 ACRES, MORE OR LESS. SUBJECT TO ALL EASEMENTS AND RIGHTS-OF-WAY OF RECORD.

#### GENERAL SURVEY NOTE:

THE UNDERGROUND UTILITIES SHOWN HAVE BEEN LOCATED FROM FIELD SURVEY INFORMATION AND EXISTING DRAWINGS THE SURVEYOR MAKES NO GUARANTEES THAT THE UNDERGROUND UTILITIES SHOWN ARE IN THE EXACT LOCATION INDICATED, ALTHOUGH THE SURVEYOR DOES CERTIFY THAT THEY ARE LOCATED AS ACCURATELY AS POSSIBLE FROM INFORMATION AVAILABLE. THE SURVEYOR HAS NOT PHYSICALLY LOCATED THE UNDERGROUND UTILITIES.

### CONTACT INFORMATION

PLANNING & ZONING:	MELISSA MCCARVILLE CITY BUSINESS MANAGER 354 WEST MAIN
	FARMINGTON, AR 72730 PHONE: (479)267–3865

(479)267 - 3805FLOYD SHELLY PUBLIC WORKS DIRECTOR 380 BROYLES

FARMINGTON, AR 72730 PHONE: (479)267-3865 (479)267 - 3805

FIRE DEPT: BILL HELLARD FIRE CHIEF 372 WEST MAIN P.O. BOX 150 FARMINGTON, AR 72730 PHONE: (479)267-3338

(479)267-3302

CITY OF FAYETTEVILLE CORY GRANDERSON 125 W. MOUNTAIN AVE. FAYETTEVILLE, AR 72701 PHONE: (479) 444-3415

> SOURCE GAS 655 E. MILLSAP RD. FAYETTEVILLE, AR 72701 PHONE: (800)563-0012

**ELECTRIC:** OZARK ELECTRIC 3641 W. WEDINGTON DR FAYETTEVILLE, AR 72704 PHONE: (800) 521-6144

WASTE MANAGEMENT SYSTEMS 11979 ARBOR ACRES RD FAYETTEVILLE, AR 72701 PHONE: (800)443-5558

TELEPHONE: PRAIRIE GROVE TELEPHONE CO 139 MOCK ST PRAIRIE GROVE, AR 72753 PHONE: (479)267-7200

PROJECT SITE ADDRESS: 700 W MAIN ST FARMINGTON, AR 72730

PARCEL: #760-01916-800 ACREAGE: 7.93

ZONING CLASSIFICATION: C-2

CHURCH OR RELIGIOUS SERVICES

OWNER: AVANCE BUSINESS SOLUTIONS P.O. BOX 1625

FARMINGTON, AR

ENGINEER/SURVEYOR: BATES & ASSOCIATES, INC. 7230 S. PLEASANT RIDGE DR FAYETTEVILLE, AR 72704 PHONE: (479) 442-9350

PEF ARCHITECT, LLC. PHILIP E. HADFIELD, ARCHITECT

42 W. LOUISE ST. FAYETTEVILLE, AR 72701 PHONE: (479) 444-8283 EMAIL: PEHÁRCHITECT@GMAIL.COM

FAX: (479) 521-9350

#### INDEX OF DRAWINGS

COVER SHEET EXISTING SITE + DEMOLITION PLAN

SITE PLAN UTILITY PLAN

GRADING + EROSION

CONTROL PLAN

LANDSCAPE PLAN 07.0-07.5 DETAILS

BUILDING SETBACKS C-2 HIGHWAY COMMERCIAL

FRONT SETBACK SIDE SETBACK 25 FEET REAR SETBACK 20 FEET LOT FRONTAGE 50 FEET CORNER LOT 35 FEET

#### PARKING REQUIREMENTS C-2 HIGHWAY COMMERCIAL CALCULATIONS WERE DONE BASED ON RESTAURANT USE: 1 SPACE FOR EVERY 4 SEATS.

NUMBER OF SEATS: 1060 SEATS PARKING REQUIRED: 265 SPACES

265 SPACES

ADA PARKING FOR 201-300 SPACES PROVIDED: REQUIRED ADA SPACES: PROPOSED ADA SPACES:


TOTAL STANDARD PARKING PROPOSED:


272 TOTAL PARKING SPACES:

#### ZONING REQUIREMENTS (C-2) & AND LOT AREA CALCULATIONS

TOTAL AREA OF SITE: 345,300.40 SQ.FT. TOTAL AREA AFTER R.O.W. DED: 319,399.38 SQ.FT. 172,441.28 (54%) GREENSPACE: IMPERIOUS AREA: 146,958.10 (46%) MAXIMUM BUILDING LOT COVERAGE: BUILDING AREA: 39574.03 SQ.FT. PROPOSED BUILDING LOT COVERAGE:

40 FT MAXIMUM BUILDING HEIGHT: PROPOSED BUILDING HEIGHT: UNDER 30FT

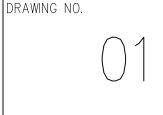

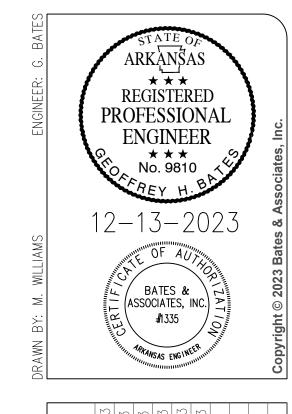


 $\forall$ m s  $\triangleleft$ 

 $\overline{Z}$ 

AND

O

0

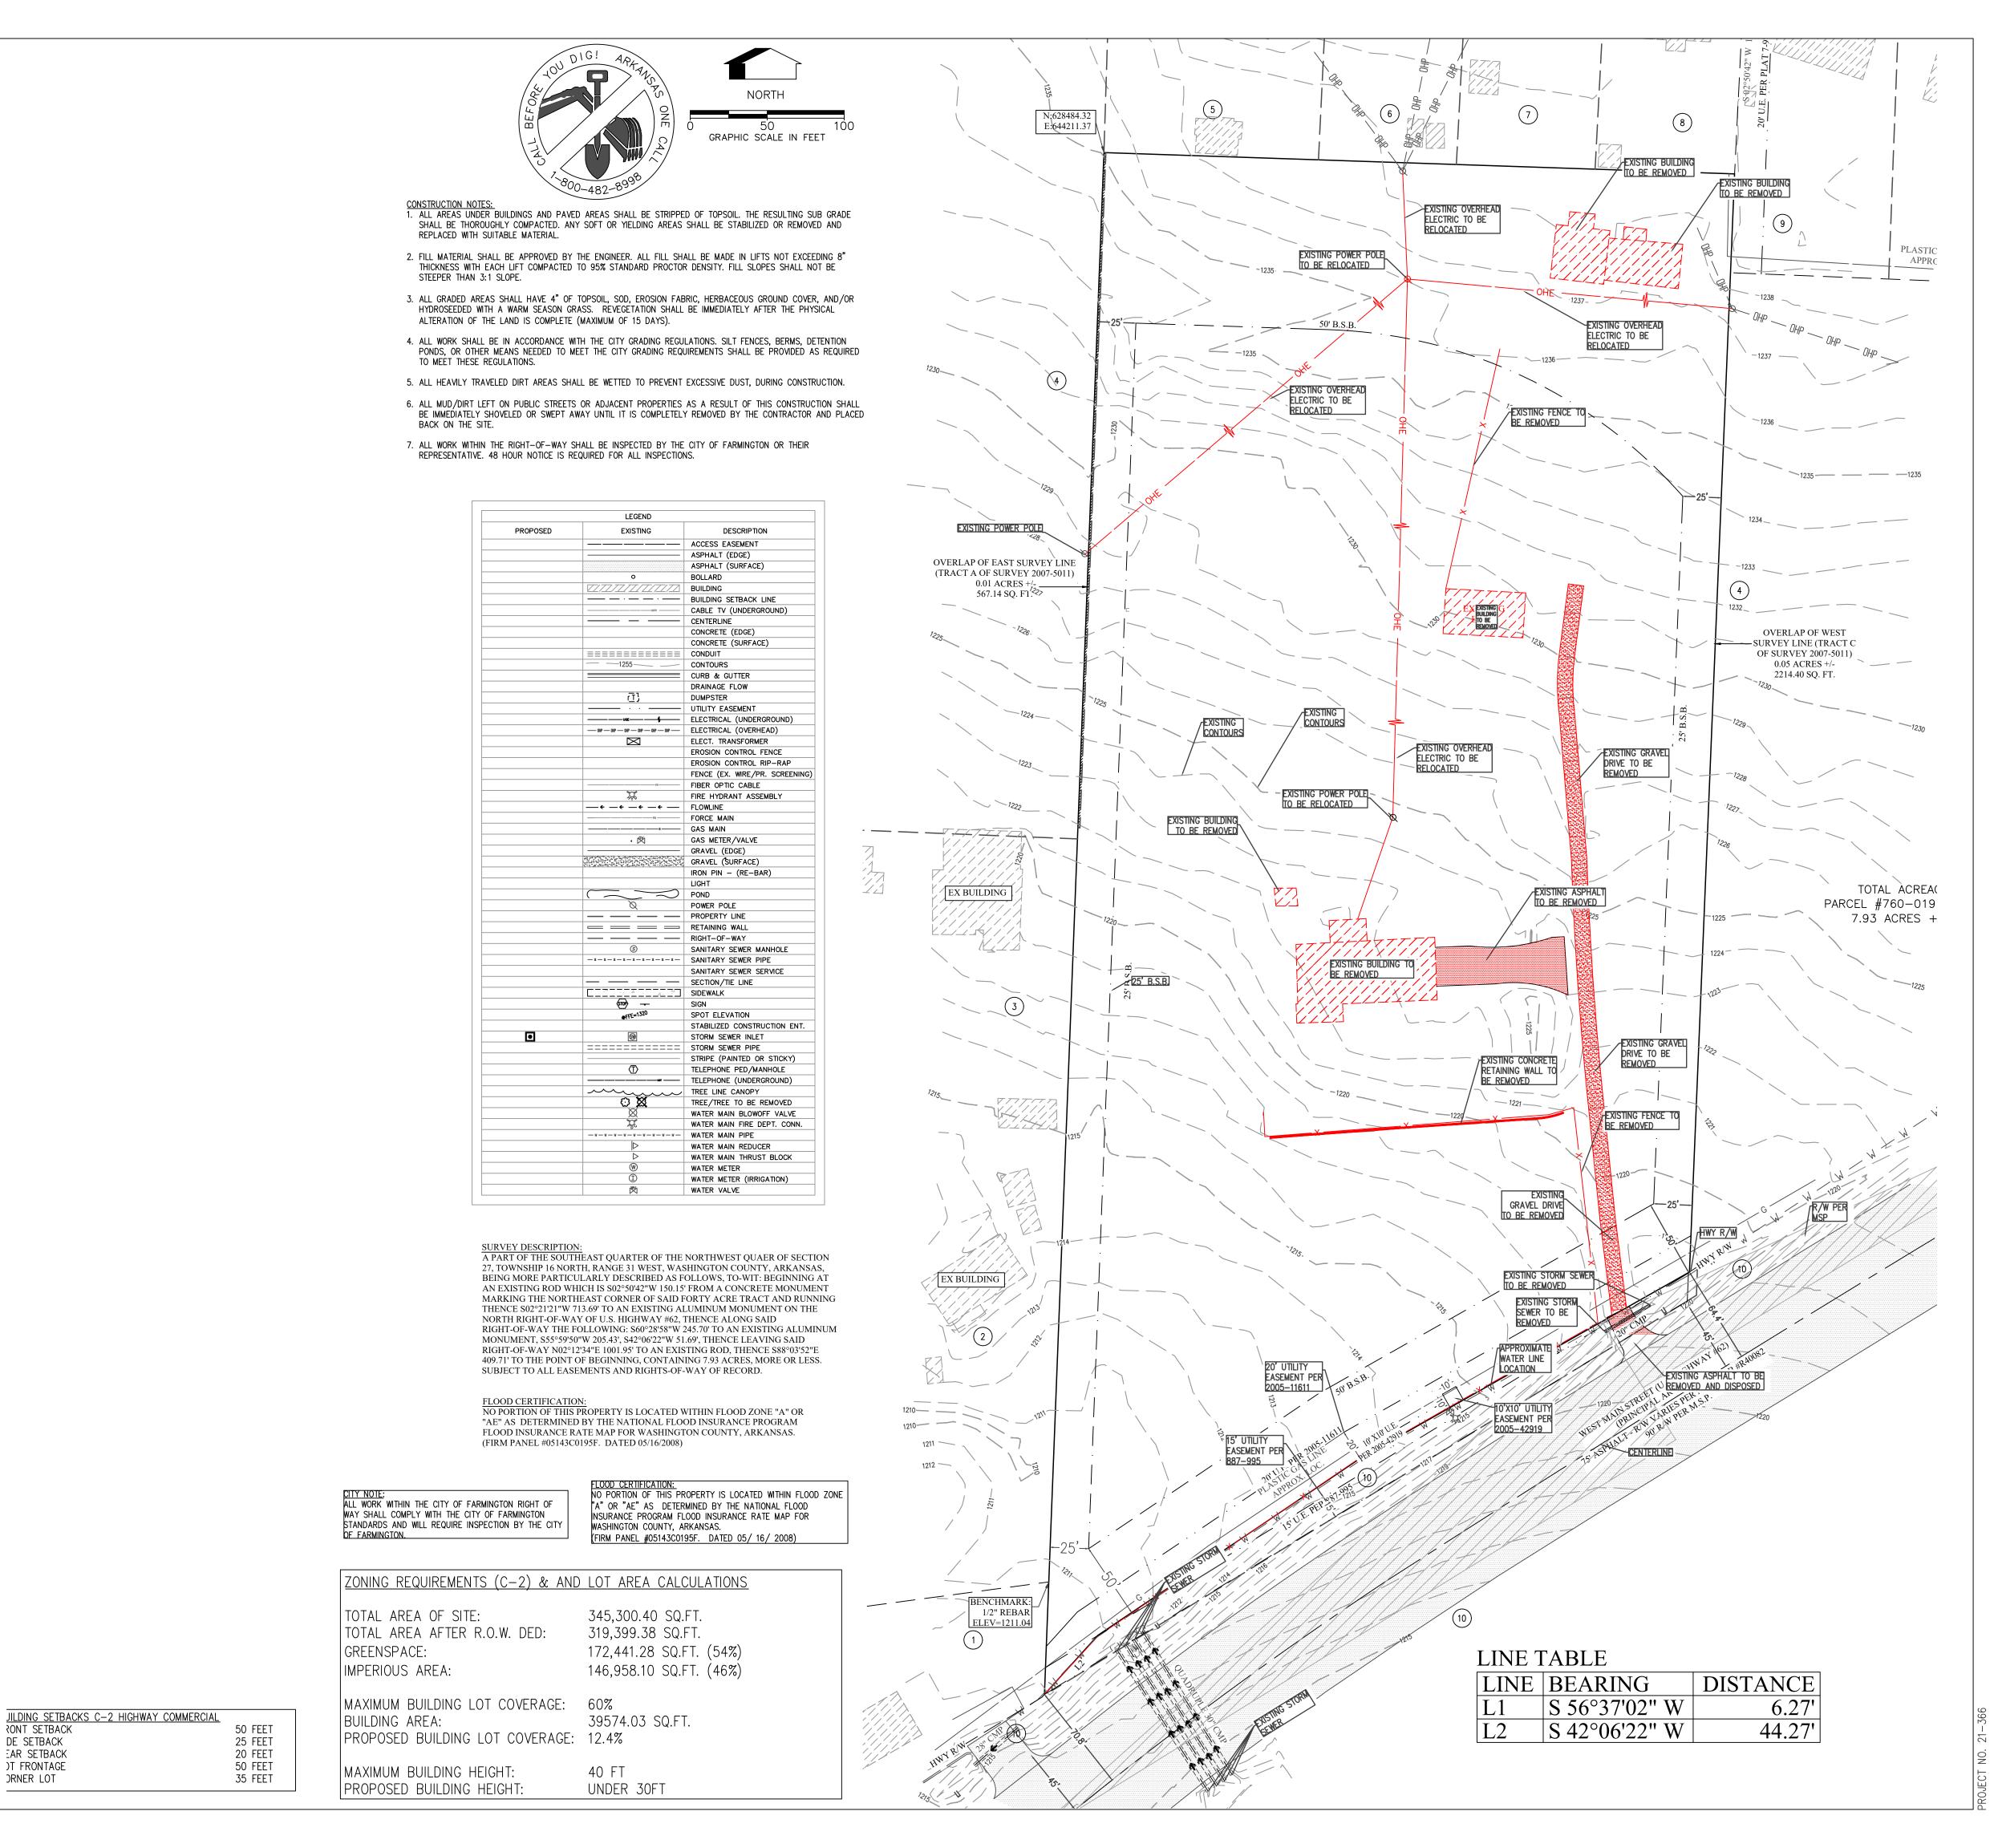

DE SETBACK

EAR SETBACK

)T FRONTAGE

ORNER LOT

REGISTERED PROFESSIONAL **ENGINEER**  $\star\star\star$ No. 9810 BATES & (ASSOCIATES, INC.) **#**1335

 $\mathcal{O}$ SION **X** 

X V

OPMEN-DEMOLITION BRAND SCALE ARGE

 $\mathbb{Z}$ 

ANS

ARMINGTON

urveyors

Engineers - 7230 S Pleasant Ridge Dr / PH: (479) 442-9350 /



CITY NOTE: ALL WORK WITHIN THE CITY OF FARMINGTON RIGHT OF WAY SHALL COMPLY WITH THE CITY OF FARMINGTON STANDARDS AND WILL REQUIRE INSPECTION BY THE CITY OF FARMINGTON.

BUILDING SETBACKS C-2 HIGHWAY COMMERCIAL FRONT SETBACK 50 FEET SIDE SETBACK 25 FEET REAR SETBACK 20 FEET 50 FEET LOT FRONTAGE CORNER LOT 35 FEET

PARKING REQUIREMENTS C-2 HIGHWAY COMMERCIAL—CALCULATIONS WERE DONE BASED ON RESTAURANT USE. 1 SPACE FOR EVERY 4 SEATS.

1060 SEATS NUMBER OF SEATS: PARKING REQUIRED: 265 SPACES PARKING PROPOSED: 265 SPACES

TOTAL STANDARD PARKING PROPOSED: 265 SPACES

ADA PARKING FOR 201-300 SPACES PROVIDED: REQUIRED ADA SPACES: PROPOSED ADA SPACES:

272 TOTAL PARKING SPACES:

#### ZONING REQUIREMENTS (C-2) & AND LOT AREA CALCULATIONS


TOTAL AREA OF SITE: 345,300.40 SQ.FT. TOTAL AREA AFTER R.O.W. DED: 319,399.38 SQ.FT. 172,441.28 SQ.FT. (54%) GREENSPACE: IMPERIOUS AREA: 146,958.10 SQ.FT. (46%)


MAXIMUM BUILDING LOT COVERAGE: 60%

39574.03 SQ.FT. BUILDING AREA: PROPOSED BUILDING LOT COVERAGE: 12.4%

MAXIMUM BUILDING HEIGHT: PROPOSED BUILDING HEIGHT: 40 FT UNDER 30FT

	LEGEND	
PROPOSED	EXISTING	DESCRIPTION
— AE — AE —		ACCESS EASEMENT
		ASPHALT (EDGE)
		ASPHALT (SURFACE)
0	0	BOLLARD
		BUILDING
		BUILDING SETBACK LINE
		CABLE TV (UNDERGROUND)
		CENTERLINE
		CONCRETE (EDGE)
		CONCRETE (SURFACE)
		CONDUIT
		CONTOURS
		CURB & GUTTER
<b>~~</b>		DRAINAGE FLOW
<b>(</b> T}	<i>(</i> ₹}	DUMPSTER
		UTILITY EASEMENT
		ELECTRICAL (UNDERGROUND)
- oe	·	ELECTRICAL (OVERHEAD)
	$\bowtie$	ELECT. TRANSFORMER
		EROSION CONTROL FENCE
		EROSION CONTROL RIP-RAP
		FENCE (EX. WIRE/PR. SCREENING)
		FIBER OPTIC CABLE
		FIRE HYDRANT ASSEMBLY
		FLOWLINE
	n	FORCE MAIN
0		GAS MAIN
& ISV1		GAS METER/VALVE
		GRAVEL (EDGE)
596095750975740		GRAVEL (SURFACE)
0	• 15 % man 12 17 18 18 18 18 18 18 18 18 18 18 18 18 18	IRON PIN - (RE-BAR)
*		LIGHT
		POND
		POWER POLE
		PROPERTY LINE
		RETAINING WALL
— R/W——— R/W——	—— R/W——	RIGHT-OF-WAY
	9	SANITARY SEWER MANHOLE
	-s-s-s-s-s-s-s-s-	SANITARY SEWER PIPE
		SANITARY SEWER SERVICE
		SECTION/TIE LINE
		SIDEWALK
(STOP) ——	(STOP) —	SIGN
	<b>●</b> FFE=1320	SPOT ELEVATION
	41:	STABILIZED CONSTRUCTION ENT.
		STORM SEWER INLET
		STORM SEWER PIPE
		STRIPE (PAINTED OR STICKY)
	Ѿ	TELEPHONE PED/MANHOLE
		TELEPHONE (UNDERGROUND)
		TREE LINE CANOPY
	0 <b>X</b>	TREE/TREE TO BE REMOVED
	w , , w ,	WATER MAIN BLOWOFF VALVE
		WATER MAIN FIRE DEPT. CONN.
		WATER MAIN PIPE
		WATER MAIN REDUCER
		WATER MAIN THRUST BLOCK
		WATER METER
(I)		
(I)		WATER METER (IRRIGATION) WATER VALVE

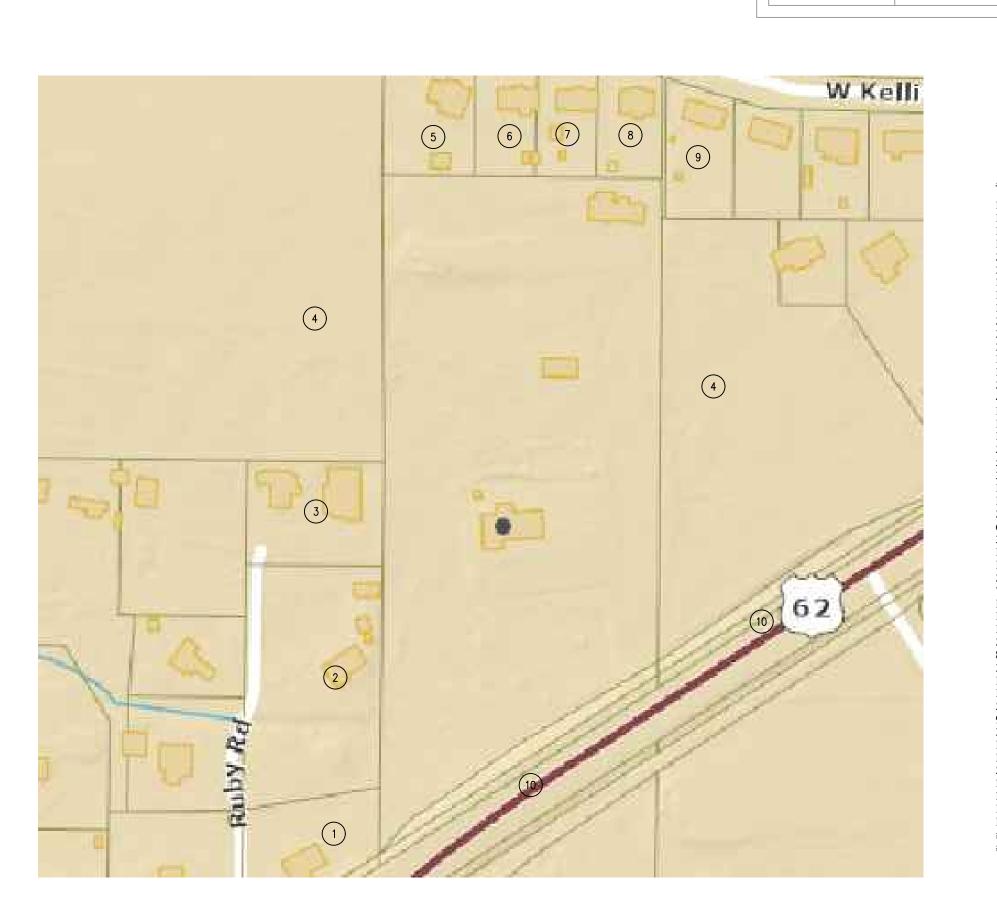

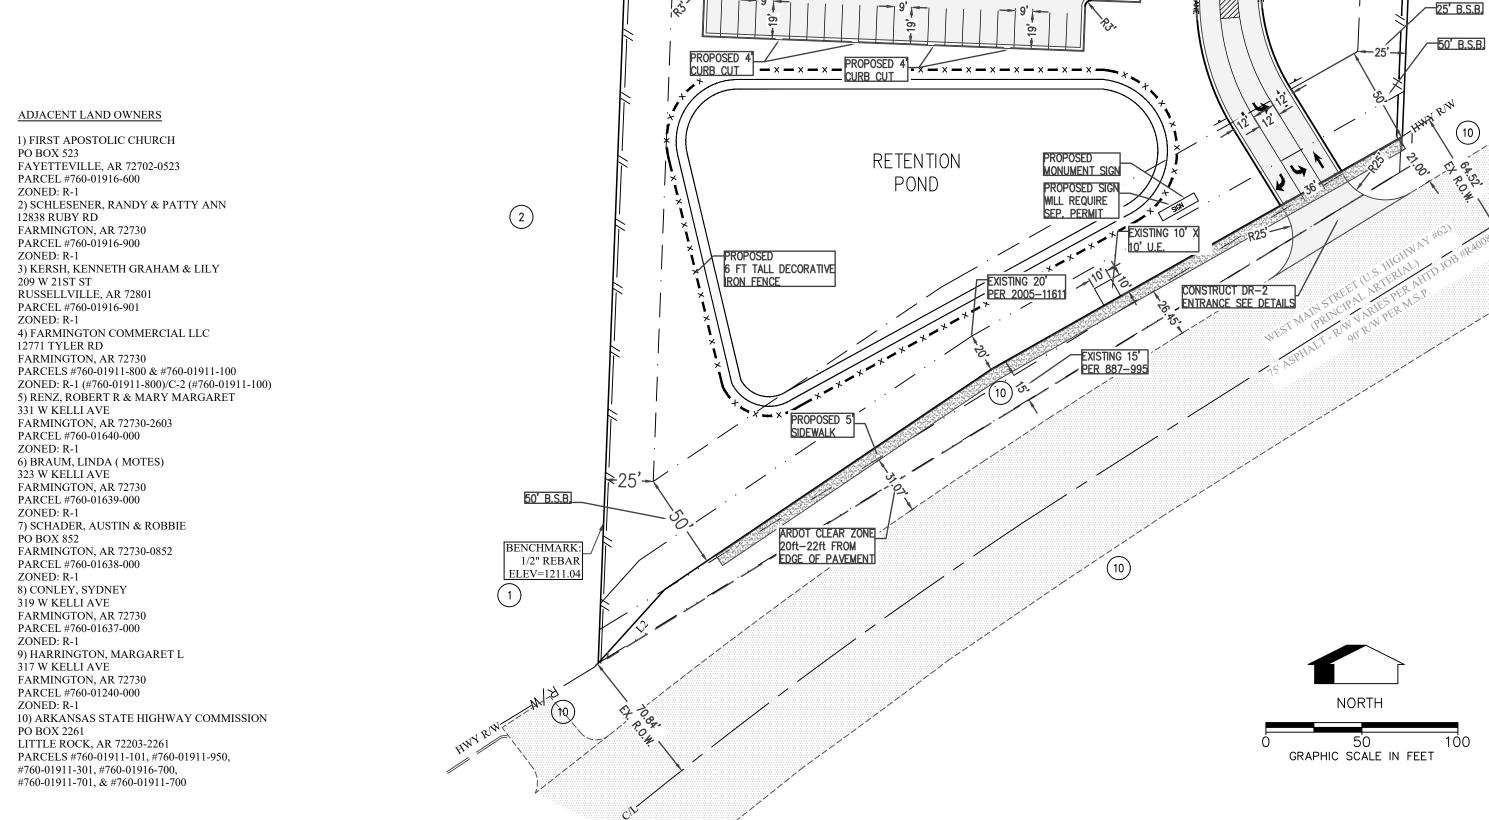

5

FIRE TRUCK TURNAROUND

PROPOSED 39,143 SQ. FT. CHURCH

PROPOSED STANDARD PARKING SPOT

PROPOSED ADA LOADING AREA

PROPOSED ADA RAMP

PROPOSED 5'

PROPOSED ADA LOADING AREA

PROPOSED ADA STRIPING

PROPOSED ADA SIGN

KNOX BOX

PROPOSED ADA SIGN

CONCRETE SIDEWALK

DROP OFF CANOPY

PROPOSED ONE WAY

DROP OFF AISLE

PROPOSED ADA RAMP

PROPOSED 2'
CURB & GUTTER

N:628484.32 E:644211.37

25' B.S.B.

4

PROPOSED 6' TALL \_\_\_\_\_\_WOOD PRIVACY FENCE

PR R/W



9

PROPOSED SCREENED DUMPSTER LOCATION

SCREENED 5' HIGH AND CONSTUCTED OF

MATERIALS MATCHING

THE PRIMARY BUILDING

LANE STRIPING

PROPOSED STACKED

BLOCK RETAINING

SHOW A SAFE ANGLE TO TURN.

PROPOSED 6' TALL

PROPOSED FIRE LANE STRIPING


WOOD PRIVACY FENCE


25' B.S.B.

REVISIONS


ANS CHURCH OPMENT BRAND SCALE LARGE

Engineers

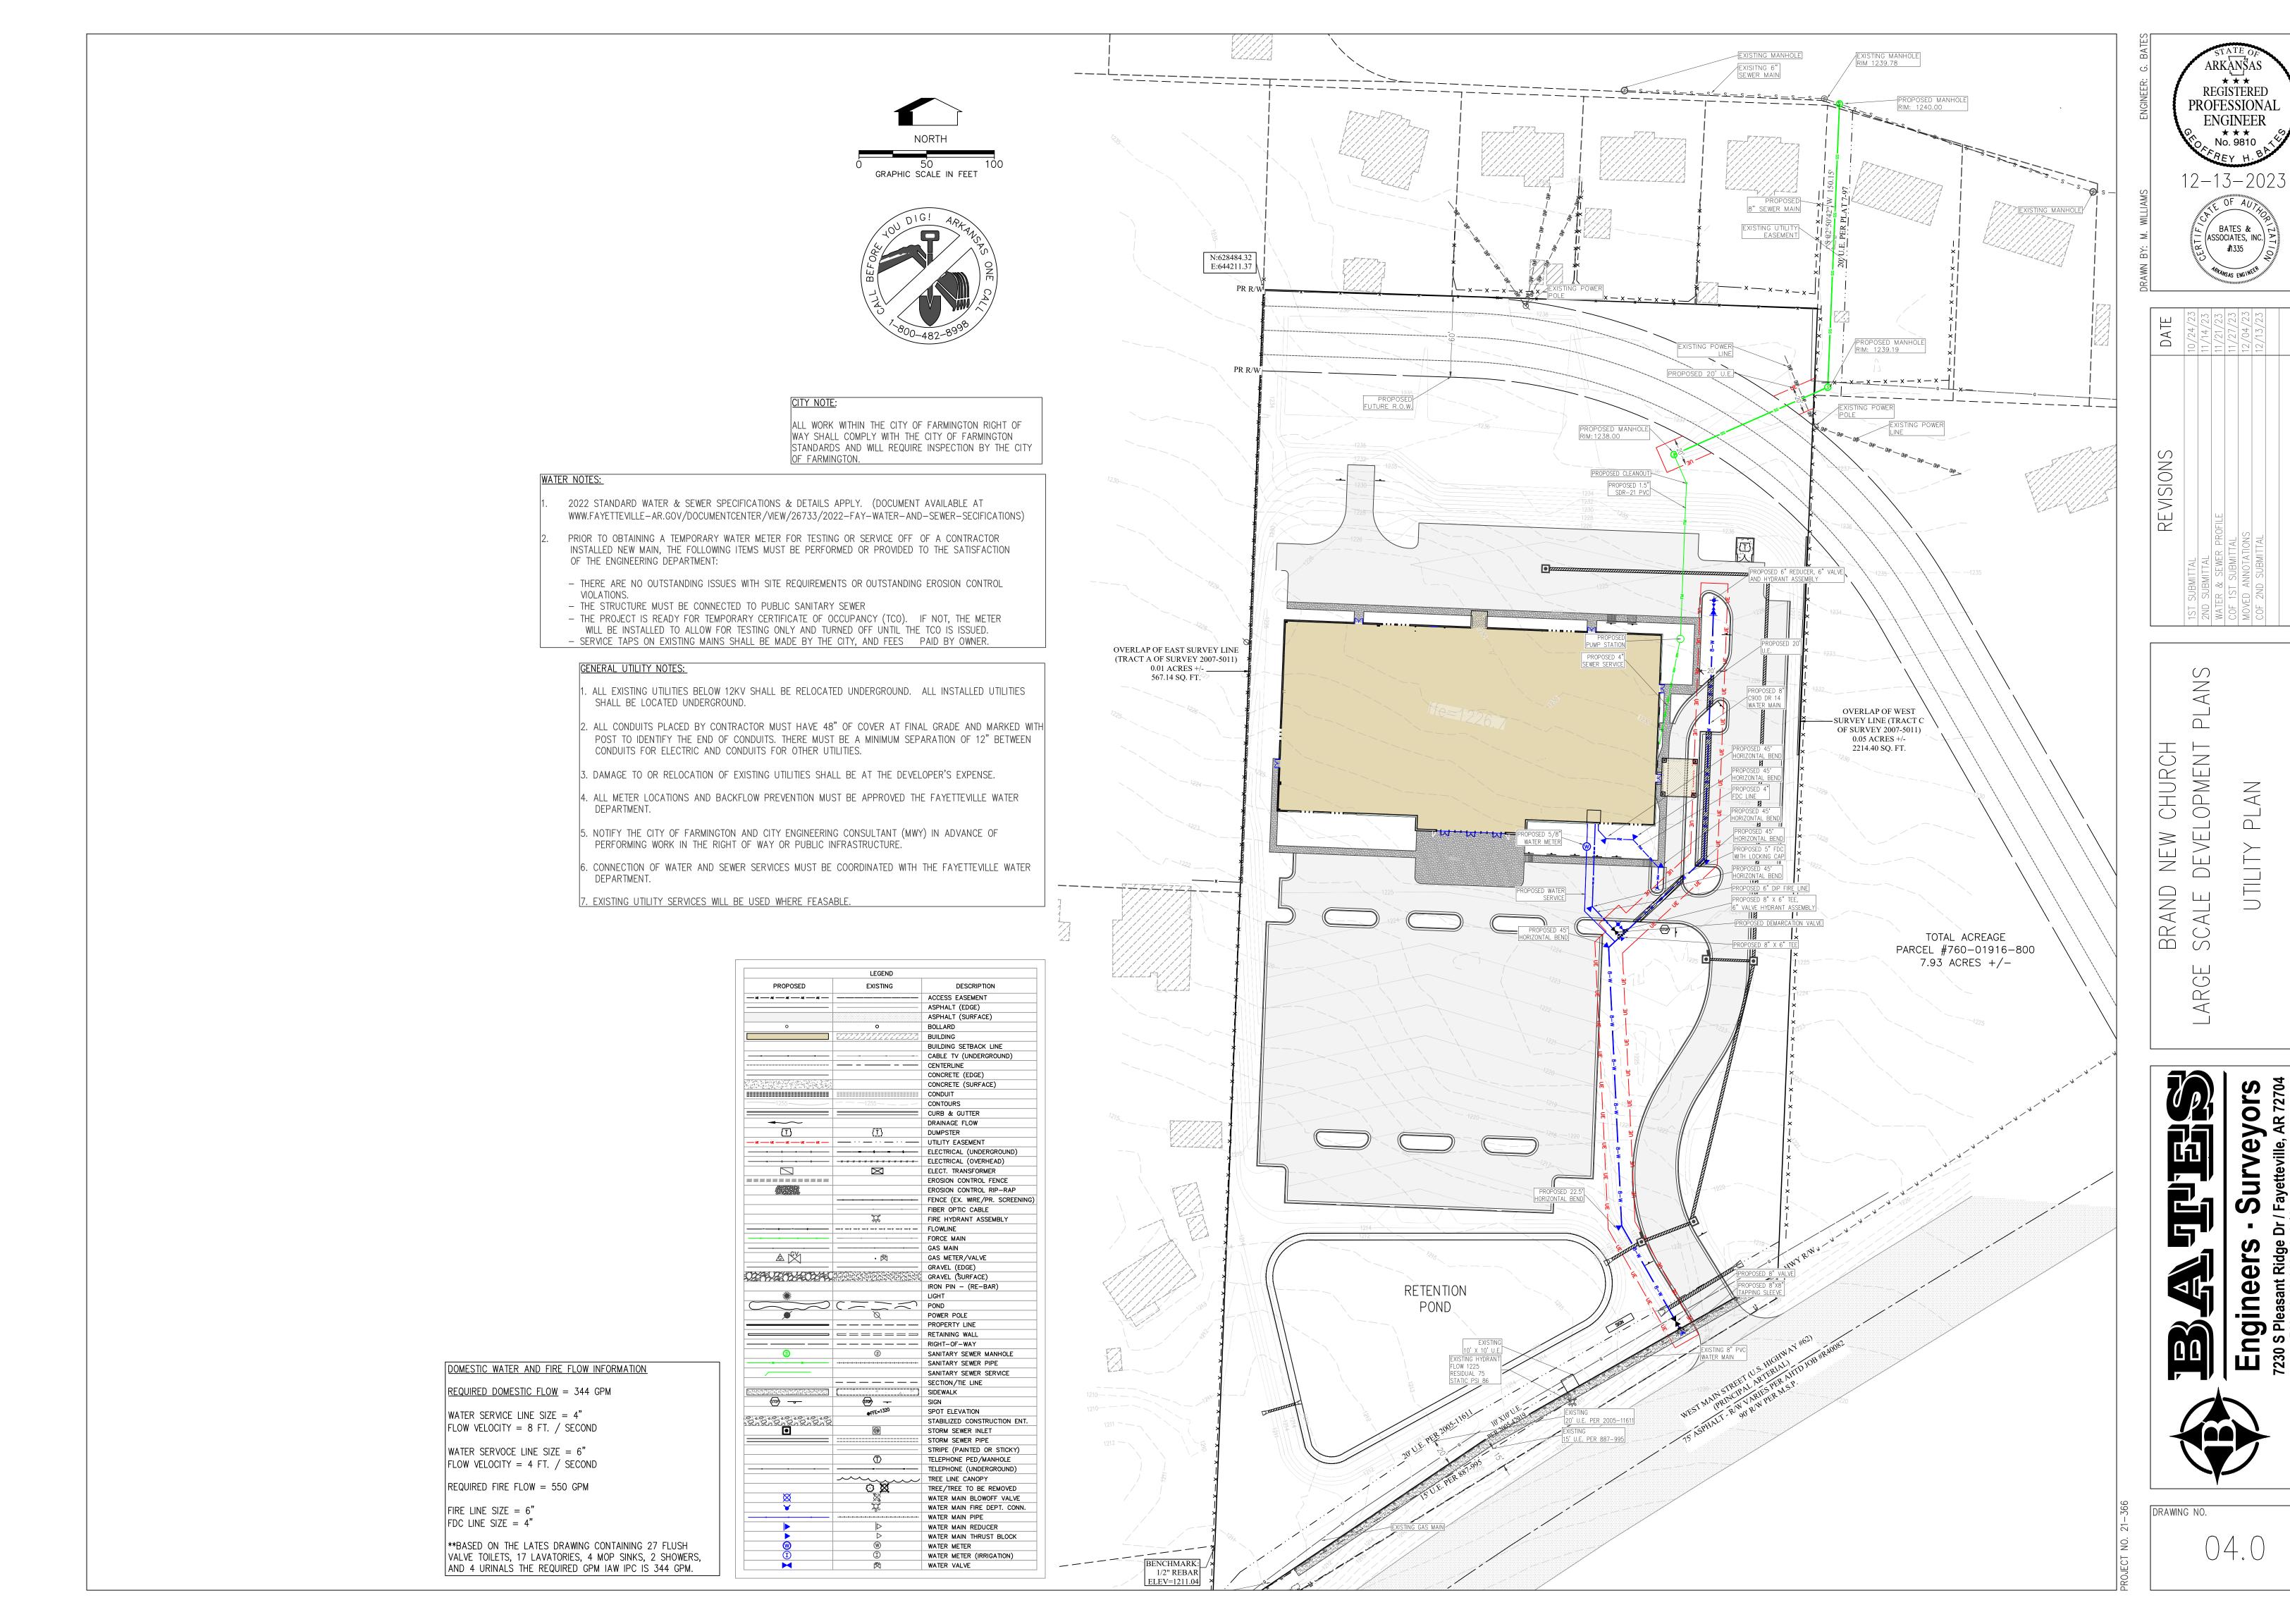

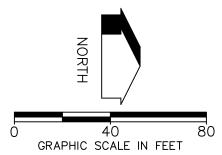



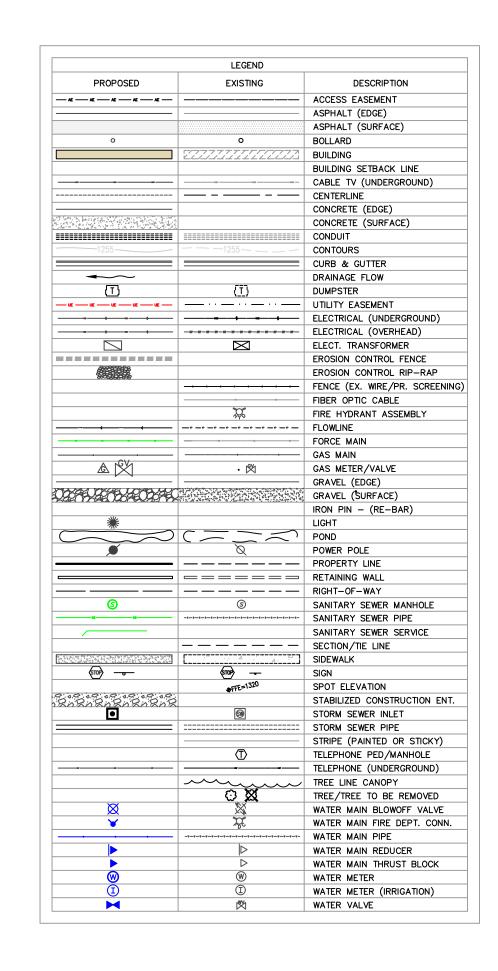

PROVIDE P C SO LEP  PROVID	1234 1232 6" VALVE
	-x-x-x-x-x-x-x-x-x-x-x-x-x-x-x-x-x-x-x

TYPE	SIZE	MATERIAL	LENGTH
FIRE	6"	C350 D.I.P.	91.58 LF
WATER	8"	C900 DR 14 PVC	582.10 LF
SEWER	8"	SDR-26 PVC	333.65 LF
	FIRE	FIRE 6" WATER 8"	FIRE 6" C350 D.I.P.  WATER 8" C900 DR 14 PVC

DOMESTIC WATER AND FIRE FLOW INFORMATION

REQUIRED DOMESTIC FLOW = 344 GPM

WATER SERVICE LINE SIZE = 4"
FLOW VELOCITY = 8 FT. / SECOND

WATER SERVOCE LINE SIZE = 6"

FLOW VELOCITY = 4 FT. / SECOND

REQUIRED FIRE FLOW = 550 GPM

FIDE LINE SIZE - 6"

FIRE LINE SIZE = 6"
FDC LINE SIZE = 4"


\*\*BASED ON THE LATES DRAWING CONTAINING 27 FLUSH VALVE TOILETS, 17 LAVATORIES, 4 MOP SINKS, 2 SHOWERS, AND 4 URINALS THE REQUIRED GPM IAW IPC IS 344 GPM.

#### CITY NOT

ALL WORK WITHIN THE CITY OF FARMINGTON RIGHT OF WAY SHALL COMPLY WITH THE CITY OF FARMINGTON STANDARDS AND WILL REQUIRE INSPECTION BY THE CITY OF FARMINGTON.

#### WATER NOTES:

- 2022 STANDARD WATER & SEWER SPECIFICATIONS & DETAILS APPLY. (DOCUMENT AVAILABLE AT WWW.FAYETTEVILLE-AR.GOV/DOCUMENTCENTER/VIEW/26733/2022-FAY-WATER-AND-SEWER-SECIFICATIONS)
- PRIOR TO OBTAINING A TEMPORARY WATER METER FOR TESTING OR SERVICE OFF OF A CONTRACTOR INSTALLED NEW MAIN, THE FOLLOWING ITEMS MUST BE PERFORMED OR PROVIDED TO THE SATISFACTION OF THE ENGINEERING DEPARTMENT:
- THERE ARE NO OUTSTANDING ISSUES WITH SITE REQUIREMENTS OR OUTSTANDING EROSION CONTROL VIOLATIONS.
- THE STRUCTURE MUST BE CONNECTED TO PUBLIC SANITARY SEWER
- THE PROJECT IS READY FOR TEMPORARY CERTIFICATE OF OCCUPANCY (TCO). IF NOT, THE METER WILL BE INSTALLED TO ALLOW FOR TESTING ONLY AND TURNED OFF UNTIL THE TCO IS ISSUED.
   SERVICE TAPS ON EXISTING MAINS SHALL BE MADE BY THE CITY, AND FEES PAID BY OWNER.

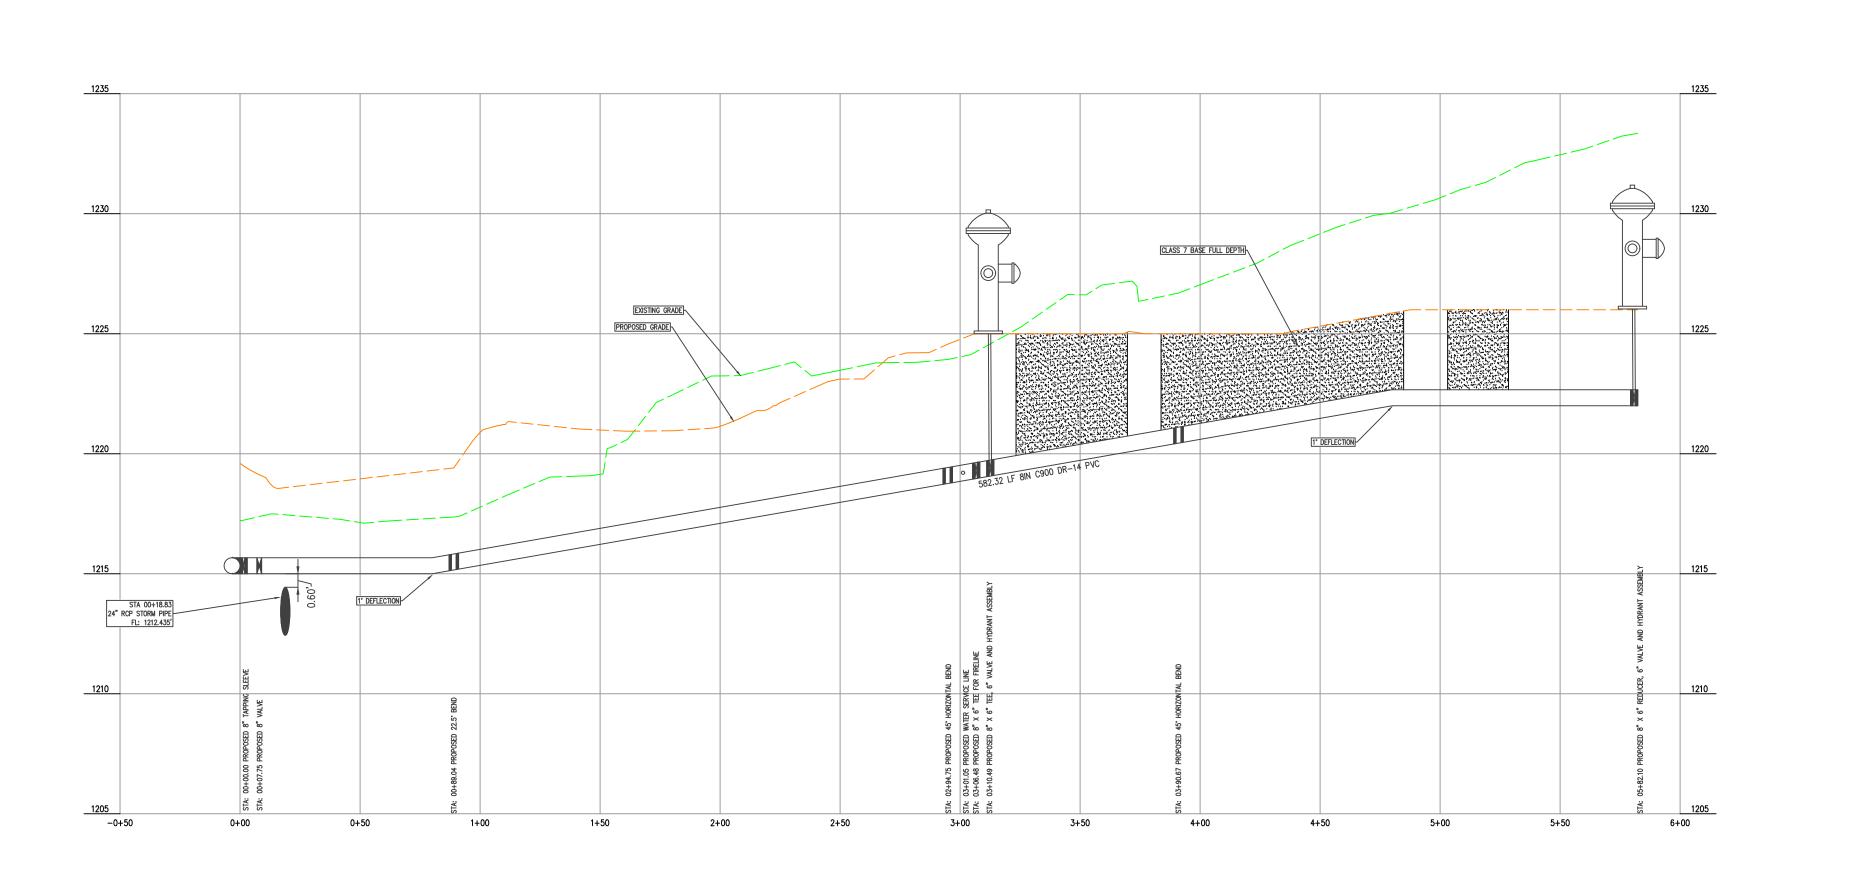

MENT PLANS

2ND SUBMITTAL

2ND SUBMITTAL

WATER & SEWER PROFILE


COF 1ST SUBMITTAL

MOVED ANNOTATIONS


COF 2ND SUBMITTAL

BRAND NEW CHURCH
LARGE SCALE DEVELOPMENT
WATERMAIN PLAN & PRO

Engineers - Surveyors
7230 S Pleasant Ridge Dr / Fayetteville, AR 72704
PH: (479) 442-9350 / batesnwa.com

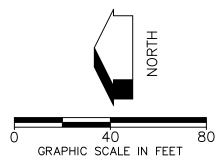



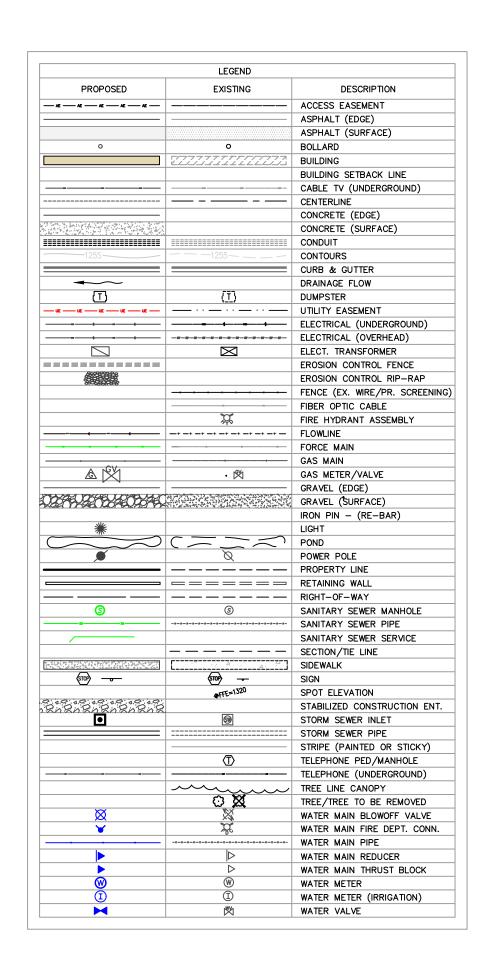

TYPE	SIZE	MATERIAL	LENGTH
FIRE	6"	C350 D.I.P.	91.58 LF
WATER	8"	C900 DR 14 PVC	582.10 LF
SEWER	8"	SDR-26 PVC	333.65 LF

DOMESTIC WATER AND FIRE FLOW INFORMATION

REQUIRED DOMESTIC FLOW = 344 GPM

WATER SERVICE LINE SIZE = 4" FLOW VELOCITY = 8 FT. / SECOND

WATER SERVOCE LINE SIZE = 6"

FLOW VELOCITY = 4 FT. / SECOND

REQUIRED FIRE FLOW = 550 GPM

FIRE LINE SIZE = 6" FDC LINE SIZE = 4"


\*\*BASED ON THE LATES DRAWING CONTAINING 27 FLUSH VALVE TOILETS, 17 LAVATORIES, 4 MOP SINKS, 2 SHOWERS, AND 4 URINALS THE REQUIRED GPM IAW IPC IS 344 GPM.


#### CITY NOTE:


ALL WORK WITHIN THE CITY OF FARMINGTON RIGHT OF WAY SHALL COMPLY WITH THE CITY OF FARMINGTON STANDARDS AND WILL REQUIRE INSPECTION BY THE CITY OF FARMINGTON.

#### WATER NOTES:

- 2022 STANDARD WATER & SEWER SPECIFICATIONS & DETAILS APPLY. (DOCUMENT AVAILABLE AT WWW.FAYETTEVILLE—AR.GOV/DOCUMENTCENTER/VIEW/26733/2022—FAY—WATER—AND—SEWER—SECIFICATIONS)
- PRIOR TO OBTAINING A TEMPORARY WATER METER FOR TESTING OR SERVICE OFF OF A CONTRACTOR INSTALLED NEW MAIN, THE FOLLOWING ITEMS MUST BE PERFORMED OR PROVIDED TO THE SATISFACTION OF THE ENGINEERING DEPARTMENT:
- THERE ARE NO OUTSTANDING ISSUES WITH SITE REQUIREMENTS OR OUTSTANDING EROSION CONTROL VIOLATIONS.
- THE STRUCTURE MUST BE CONNECTED TO PUBLIC SANITARY SEWER
- THE PROJECT IS READY FOR TEMPORARY CERTIFICATE OF OCCUPANCY (TCO). IF NOT, THE METER WILL BE INSTALLED TO ALLOW FOR TESTING ONLY AND TURNED OFF UNTIL THE TCO IS ISSUED.
   SERVICE TAPS ON EXISTING MAINS SHALL BE MADE BY THE CITY, AND FEES PAID BY OWNER.

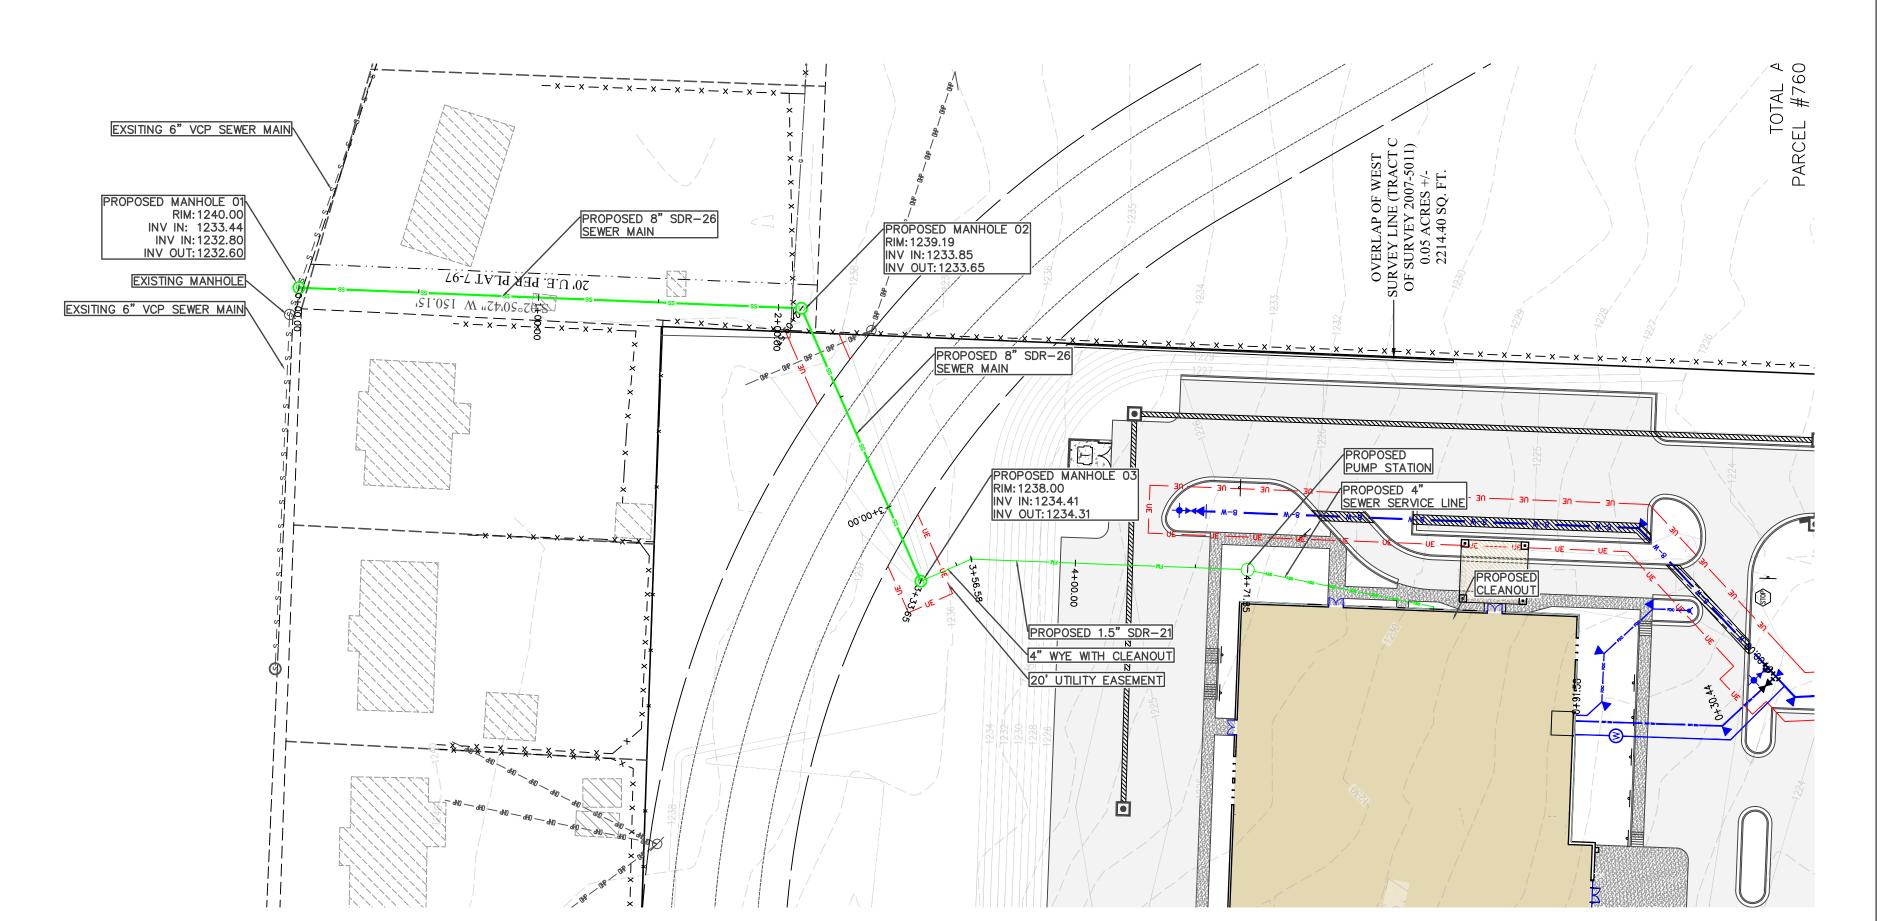

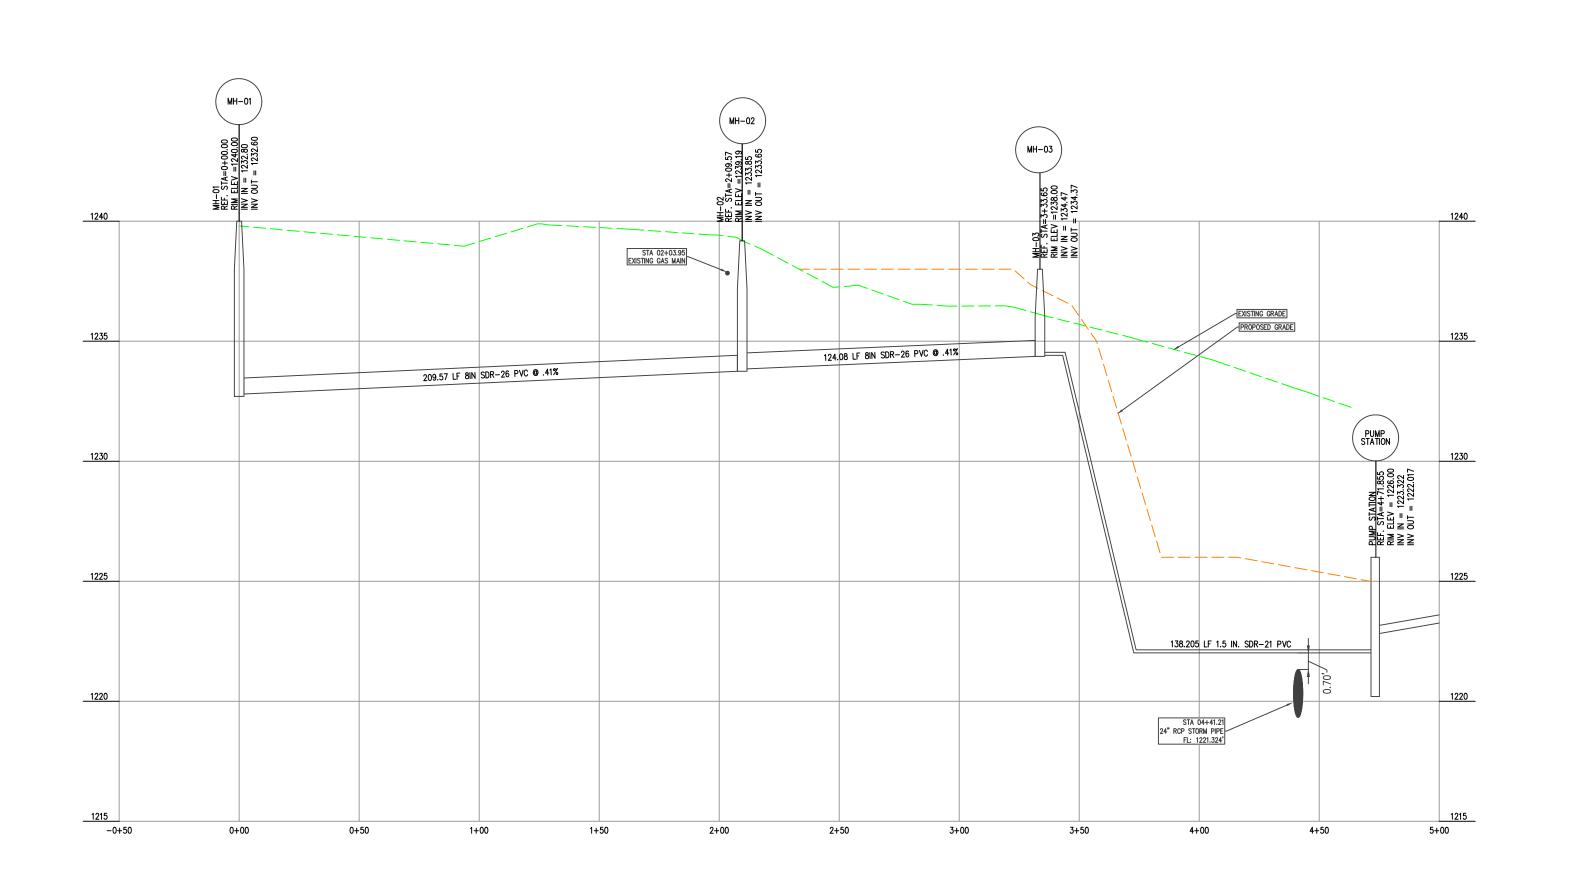

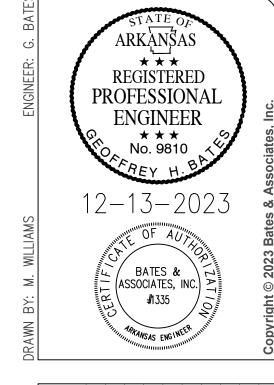

REVISIONS

10/24/25

10 SUBMITTAL

11/14/23

ATER & SEWER PROFILE

11/21/23

DF 1ST SUBMITTAL

11/27/23

DF 2ND SUBMITTAL

12/04/25

12/13/23


BRAND NEW CHURCH
LARGE SCALE DEVELOPMENT PLANS
SEWER PLAN & PROFILE

ANS,






DRAWING NO.

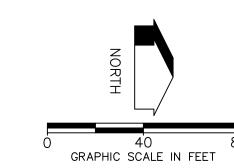



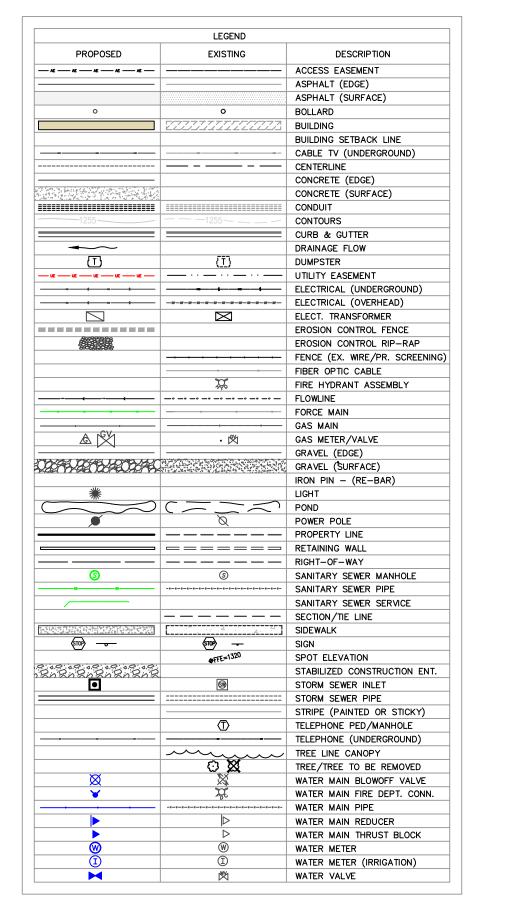

				$\neg$
TYPE	SIZE	MATERIAL	LENGTH	
FIRE	6"	C350 D.I.P.	91.58 LF	
WATER	8"	C900 DR 14 PVC	582.10 LF	
SEWER	8"	SDR-26 PVC	333.65 LF	

DOMESTIC WATER AND FIRE FLOW INFORMATION

REQUIRED DOMESTIC FLOW = 344 GPM

WATER SERVICE LINE SIZE = 4"
FLOW VELOCITY = 8 FT. / SECOND

WATER SERVOCE LINE SIZE = 6"

FLOW VELOCITY = 4 FT. / SECOND

REQUIRED FIRE FLOW = 550 GPM

FIRE LINE SIZE = 6"

FDC LINE SIZE = 4"

\*\*BASED ON THE LATES DRAWING CONTAINING 27 FLUSH
VALVE TOILETS, 17 LAVATORIES, 4 MOP SINKS, 2 SHOWERS,


AND 4 URINALS THE REQUIRED GPM IAW IPC IS 344 GPM.


#### CITY NOTE:


ALL WORK WITHIN THE CITY OF FARMINGTON RIGHT OF WAY SHALL COMPLY WITH THE CITY OF FARMINGTON STANDARDS AND WILL REQUIRE INSPECTION BY THE CITY OF FARMINGTON.

#### WATER NOTES:

- 1. 2022 STANDARD WATER & SEWER SPECIFICATIONS & DETAILS APPLY. (DOCUMENT AVAILABLE AT WWW.FAYETTEVILLE—AR.GOV/DOCUMENTCENTER/VIEW/26733/2022—FAY—WATER—AND—SEWER—SECIFICATIONS)
- PRIOR TO OBTAINING A TEMPORARY WATER METER FOR TESTING OR SERVICE OFF OF A CONTRACTOR INSTALLED NEW MAIN, THE FOLLOWING ITEMS MUST BE PERFORMED OR PROVIDED TO THE SATISFACTION OF THE ENGINEERING DEPARTMENT:
- THERE ARE NO OUTSTANDING ISSUES WITH SITE REQUIREMENTS OR OUTSTANDING EROSION CONTROL VIOLATIONS.
- THE STRUCTURE MUST BE CONNECTED TO PUBLIC SANITARY SEWER
- THE PROJECT IS READY FOR TEMPORARY CERTIFICATE OF OCCUPANCY (TCO). IF NOT, THE METER WILL BE INSTALLED TO ALLOW FOR TESTING ONLY AND TURNED OFF UNTIL THE TCO IS ISSUED.
   SERVICE TAPS ON EXISTING MAINS SHALL BE MADE BY THE CITY, AND FEES PAID BY OWNER.

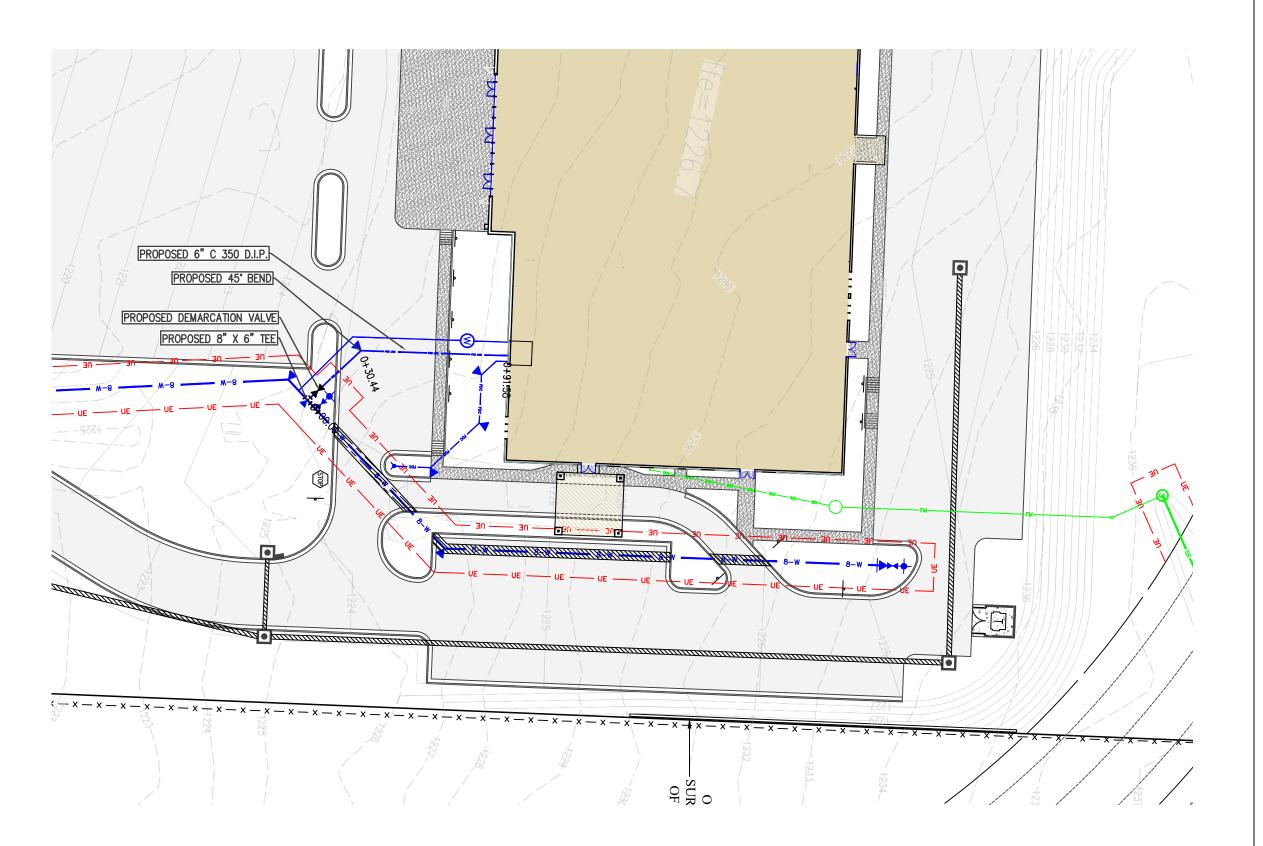

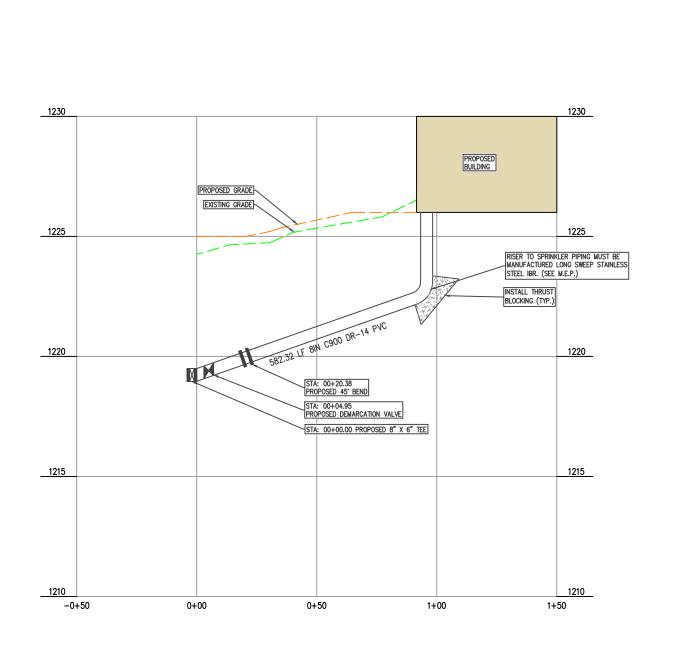

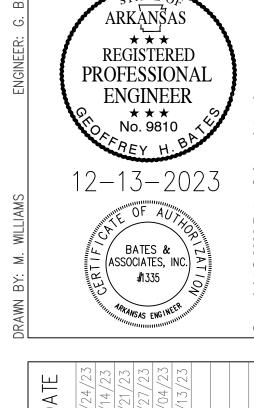

BMITTAL

BMITTAL

& SEWER PROFILE

T SUBMITTAL

ANNOTATIONS

DATE

10/24/2

11/14/2

11/21/2

11/27/2

ANNOTATIONS

DATE

11/14/2

11/21/2

12/04/2

12/04/2

BRAND NEW CHURCH


SE SCALE DEVELOPMENT PLANS

ATERMAIN PLAN & PROFILE

Sers - Surveyors

Engineers
7230 S Pleasant Ridge I
PH: (479) 442-935

DRAWING NO.

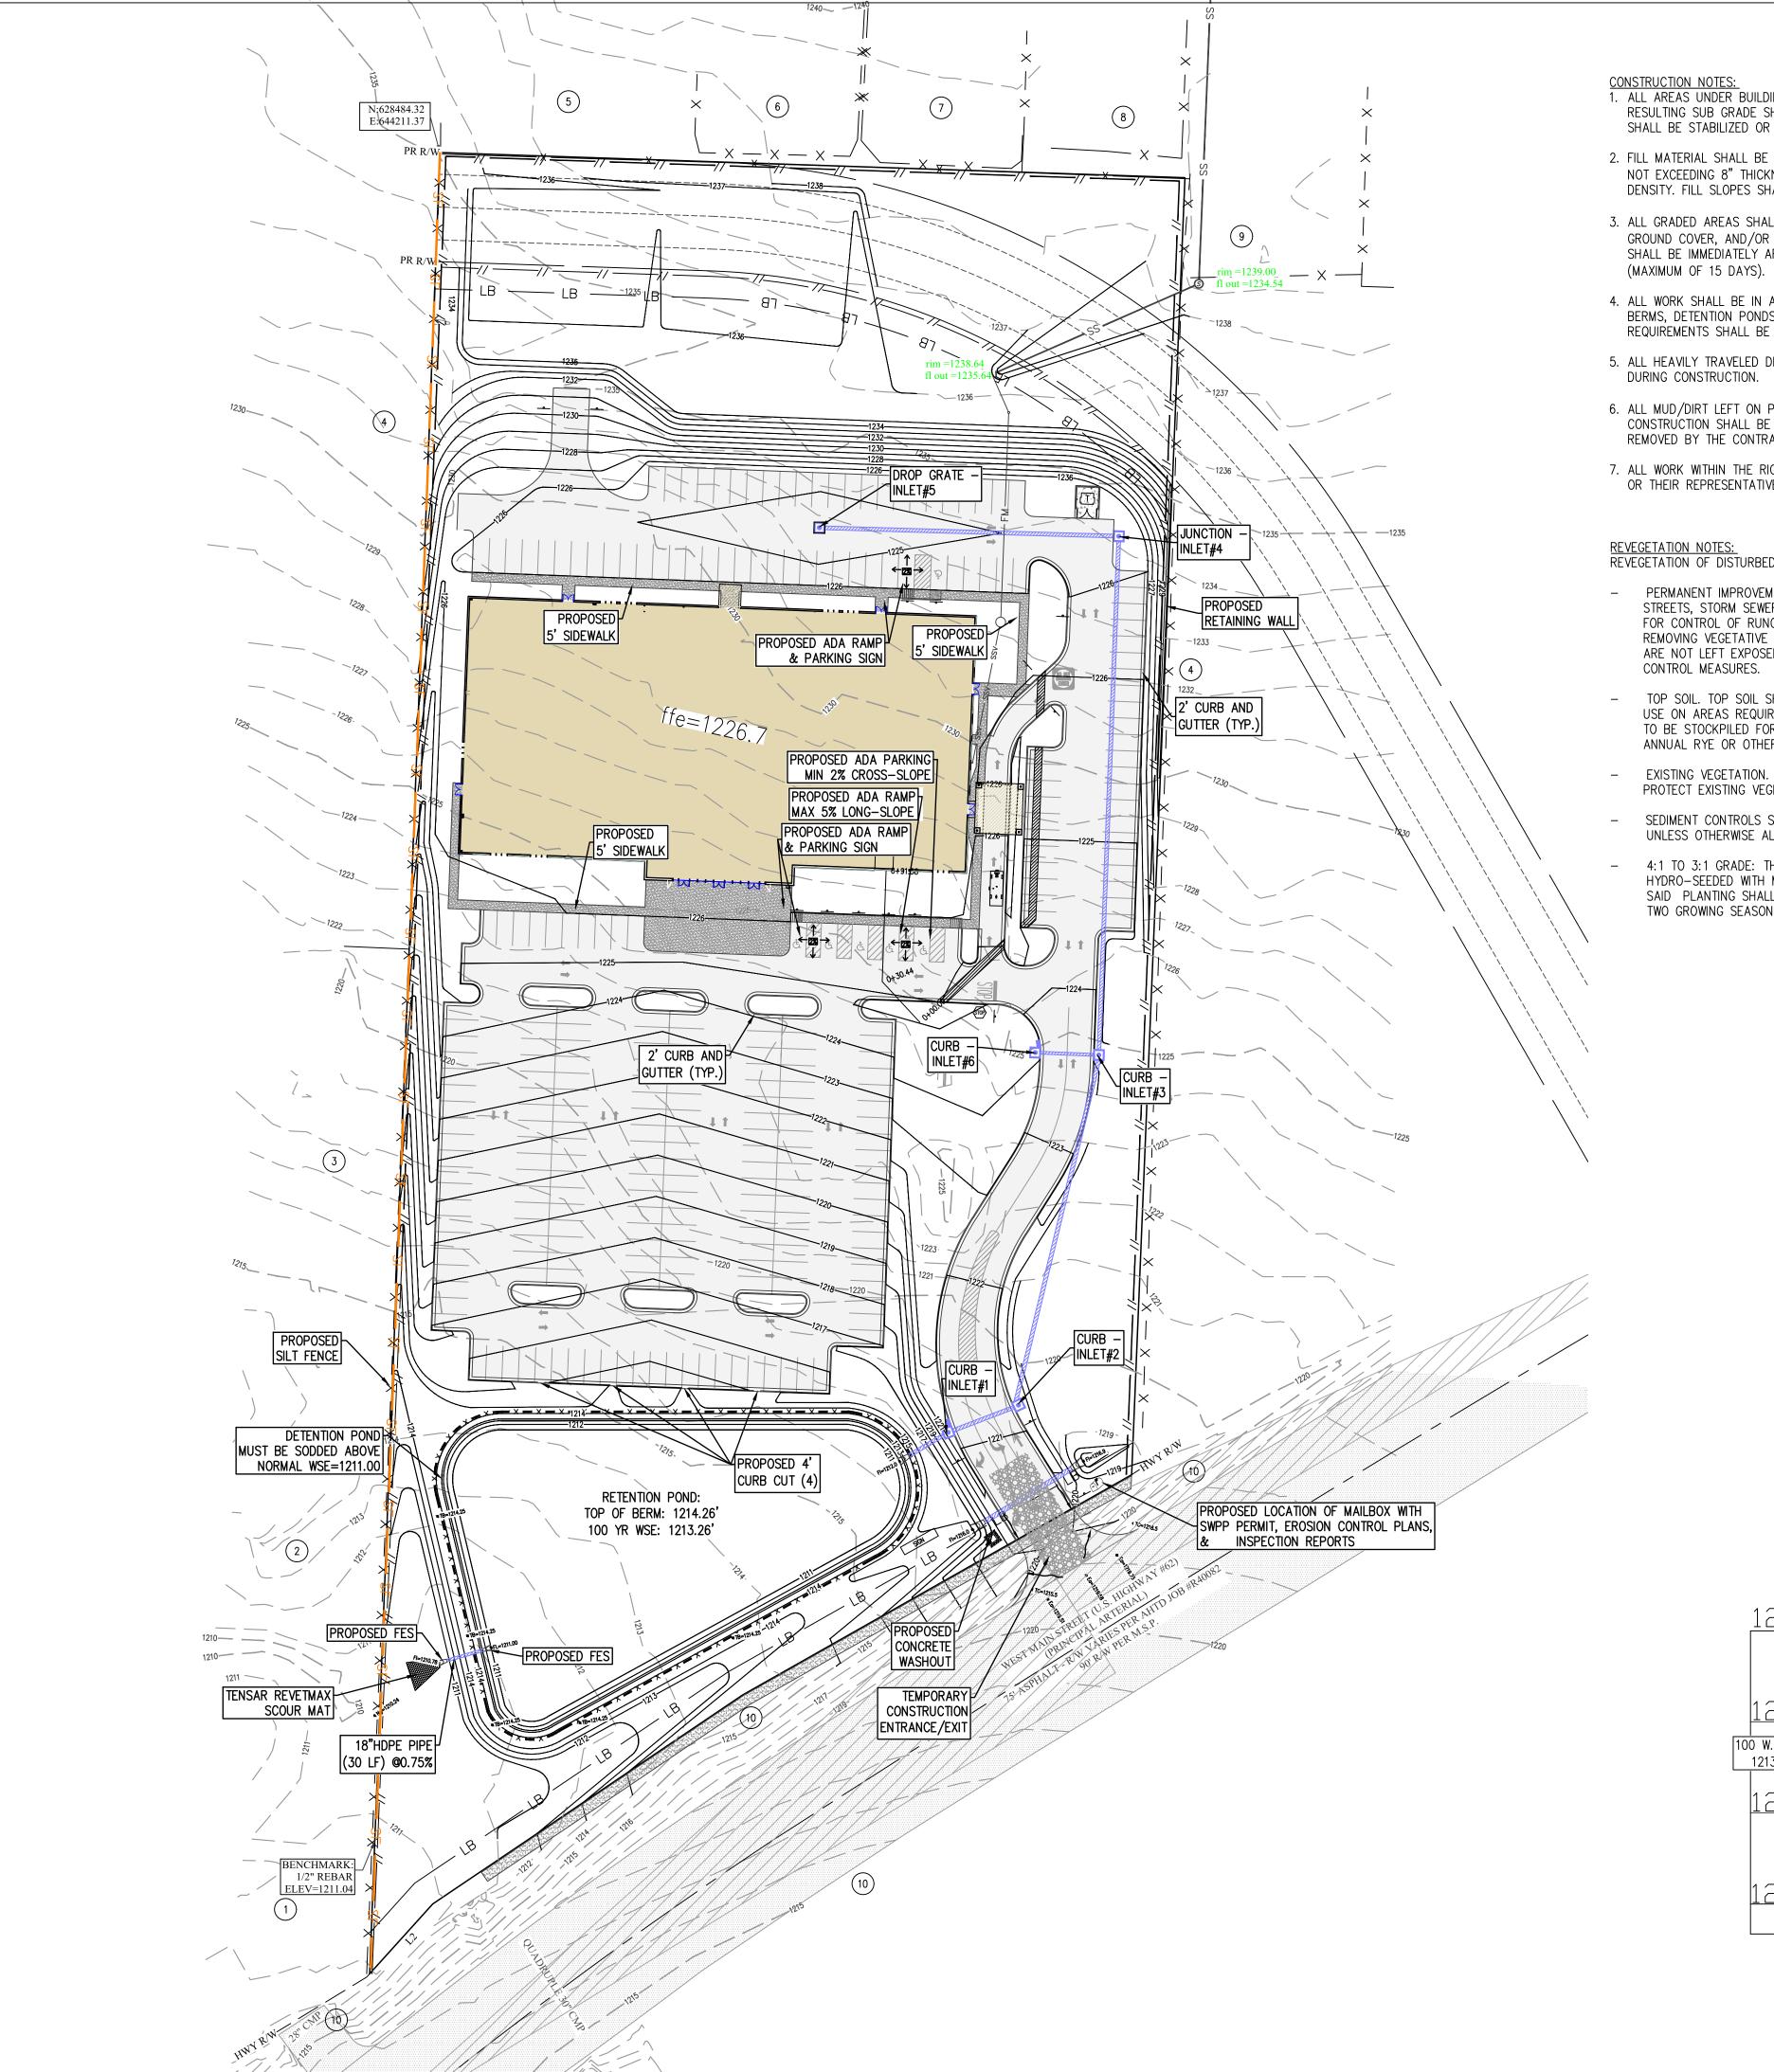

1. ALL AREAS UNDER BUILDINGS AND PAVED AREAS SHALL BE STRIPPED OF TOPSOIL. THE RESULTING SUB GRADE SHALL BE THOROUGHLY COMPACTED. ANY SOFT OR YIELDING AREAS SHALL BE STABILIZED OR REMOVED AND REPLACED WITH SUITABLE MATERIAL.

2. FILL MATERIAL SHALL BE APPROVED BY THE ENGINEER. ALL FILL SHALL BE MADE IN LIFTS NOT EXCEEDING 8" THICKNESS WITH EACH LIFT COMPACTED TO 95% STANDARD PROCTOR DENSITY. FILL SLOPES SHALL NOT BE STEEPER THAN 3:1 SLOPE.

- 3. ALL GRADED AREAS SHALL HAVE 4" OF TOPSOIL, SOD, EROSION FABRIC, HERBACEOUS GROUND COVER, AND/OR HYDROSEEDED WITH A WARM SEASON GRASS. REVEGETATION SHALL BE IMMEDIATELY AFTER THE PHYSICAL ALTERATION OF THE LAND IS COMPLETE
- 4. ALL WORK SHALL BE IN ACCORDANCE WITH THE CITY GRADING REGULATIONS. SILT FENCES, BERMS, DETENTION PONDS, OR OTHER MEANS NEEDED TO MEET THE CITY GRADING REQUIREMENTS SHALL BE PROVIDED AS REQUIRED TO MEET THESE REGULATIONS.
- 5. ALL HEAVILY TRAVELED DIRT AREAS SHALL BE WETTED TO PREVENT EXCESSIVE DUST, DURING CONSTRUCTION.
- 6. ALL MUD/DIRT LEFT ON PUBLIC STREETS OR ADJACENT PROPERTIES AS A RESULT OF THIS CONSTRUCTION SHALL BE IMMEDIATELY SHOVELED OR SWEPT AWAY UNTIL IT IS COMPLETELY REMOVED BY THE CONTRACTOR AND PLACED BACK ON THE SITE.
- 7. ALL WORK WITHIN THE RIGHT-OF-WAY SHALL BE INSPECTED BY THE CITY OF FARMINGTON OR THEIR REPRESENTATIVE. 48 HOUR NOTICE IS REQUIRED FOR ALL INSPECTIONS.

#### REVEGETATION NOTES: REVEGETATION OF DISTURBED AREAS SHALL BE IN ACCORDANCE THE FOLLOWING:

- PERMANENT IMPROVEMENTS. PERMANENT IMPROVEMENTS SUCH AS STREETS, STORM SEWERS, CURB AND GUTTERS, AND OTHER FEATURES FOR CONTROL OF RUNOFF SHALL BE SCHEDULED COINCIDENTAL TO REMOVING VEGETATIVE COVER FROM THE AREA SO THAT LARGE AREAS ARE NOT LEFT EXPOSED BEYOND THE CAPACITY OF TEMPORARY CONTROL MEASURES.
- TOP SOIL. TOP SOIL SHALL BE STOCKPILED AND PROTECTED FOR LATER USE ON AREAS REQUIRING LANDSCAPING. IF TOP SOIL OR OTHER SOIL IS TO BE STOCKPILED FOR MORE THAN 30 DAYS, A TEMPORARY COVER OF ANNUAL RYE OR OTHER SUITABLE GRASS SHALL BE PLANTED.
- EXISTING VEGETATION. EVERY MEANS SHALL BE TAKEN TO CONSERVE AND PROTECT EXISTING VEGETATION.
- SEDIMENT CONTROLS SHALL REMAIN IN PLACE UNTIL RE- VEGETATION IS ESTABLISHED UNLESS OTHERWISE ALLOWED BY THE CITY.
- 4:1 TO 3:1 GRADE: THE SLOPE SHALL BE COVERED WITH LANDSCAPE FABRIC AND HYDRO-SEEDED WITH MULCH AND FERTILIZER, OR STAKED SOD, OR GROUNDCOVER. SAID PLANTING SHALL PROVIDE COMPLETE AND UNIFORM COVERAGE IN NO MORE THAN TWO GROWING SEASONS.

PROPOSED GROUND

PROPOSED

WET DETENTION POND PROFILE

(1)18" HDPE 30LF @0.75%


100 W.S.EL 1213.26'

PROPOSED

FL: 1211.00'



SEDIMENT & EROSION CONTROL NOTES:

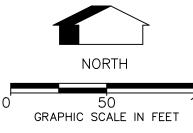

1. CONTRACTOR SHALL OBTAIN ALL PERMITS REQUIRED FROM A.D.E.Q. AND CITY REGARDING RUNOFF, EROSION CONTROL, AND GRADING BEFORE BEGINNING

3. ALL EROSION & SEDIMENT CONTROL DEVICES SHALL BE MAINTAINED AND OCCASIONALLY REPLACED THROUGHOUT THE CONSTRUCTION PROCESS.

2. CONTRACTOR SHALL POST STORM WATER POLLUTION PREVENTION PLAN.

- 4. ALL EROSION & SEDIMENT CONTROL DEVICES SHOWN SHALL BE INSTALLED BEFORE CONSTRUCTION BEGINS. THOSE ITEMS SHALL REMAIN IN PLACE UNTIL ALL EXCAVATION
- 5. THE PROPERTY OWNER OR MAIN CONTRACTOR ONSITE WILL BE RESPONSIBLE FOR RESTORING ALL EROSION AND SEDIMENT CONTROL SYSTEMS AND PUBLIC INFRASTRUCTURE DAMAGE OR DISTURBED BY UNDERGROUND PRIVATE FRANCHISED UTILITY CONSTRICTION SUCH AS WATER AND SEWER SERVICE LEADS, TELEPHONE, GAS, CABLE, ETC. EROSION AND SEDIMENT CONTROL SYSTEMS MUST BE IMMEDIATELY RESTORED AFTER EACH UTILITY CONSTRUCTION

PROPOSED 6' BERM @ 1214.26'

0+0 0+05 0+10 0+15 0+20 0+25 0+30

PROPOSED

FL: 1210.78'

18" FES

THERE ARE NO WET LANDS ON THIS PROPERTY.

HORIZONTAL SCALE 1" =5' VERTICAL SCALE 1" =3'


 $\star\star\star$ REGISTERED **PROFESSIONAL ENGINEER** \*\*\* No. 9810 12-13-2023 BATES & (ASSOCIATES, INC.) ≥ **#**1335

OPMEN BRAND SCALE LARGE


ARMINGTON

 $\mathbb{Z}$ 

Engineers - Sur 7230 S Pleasant Ridge Dr / Fayett

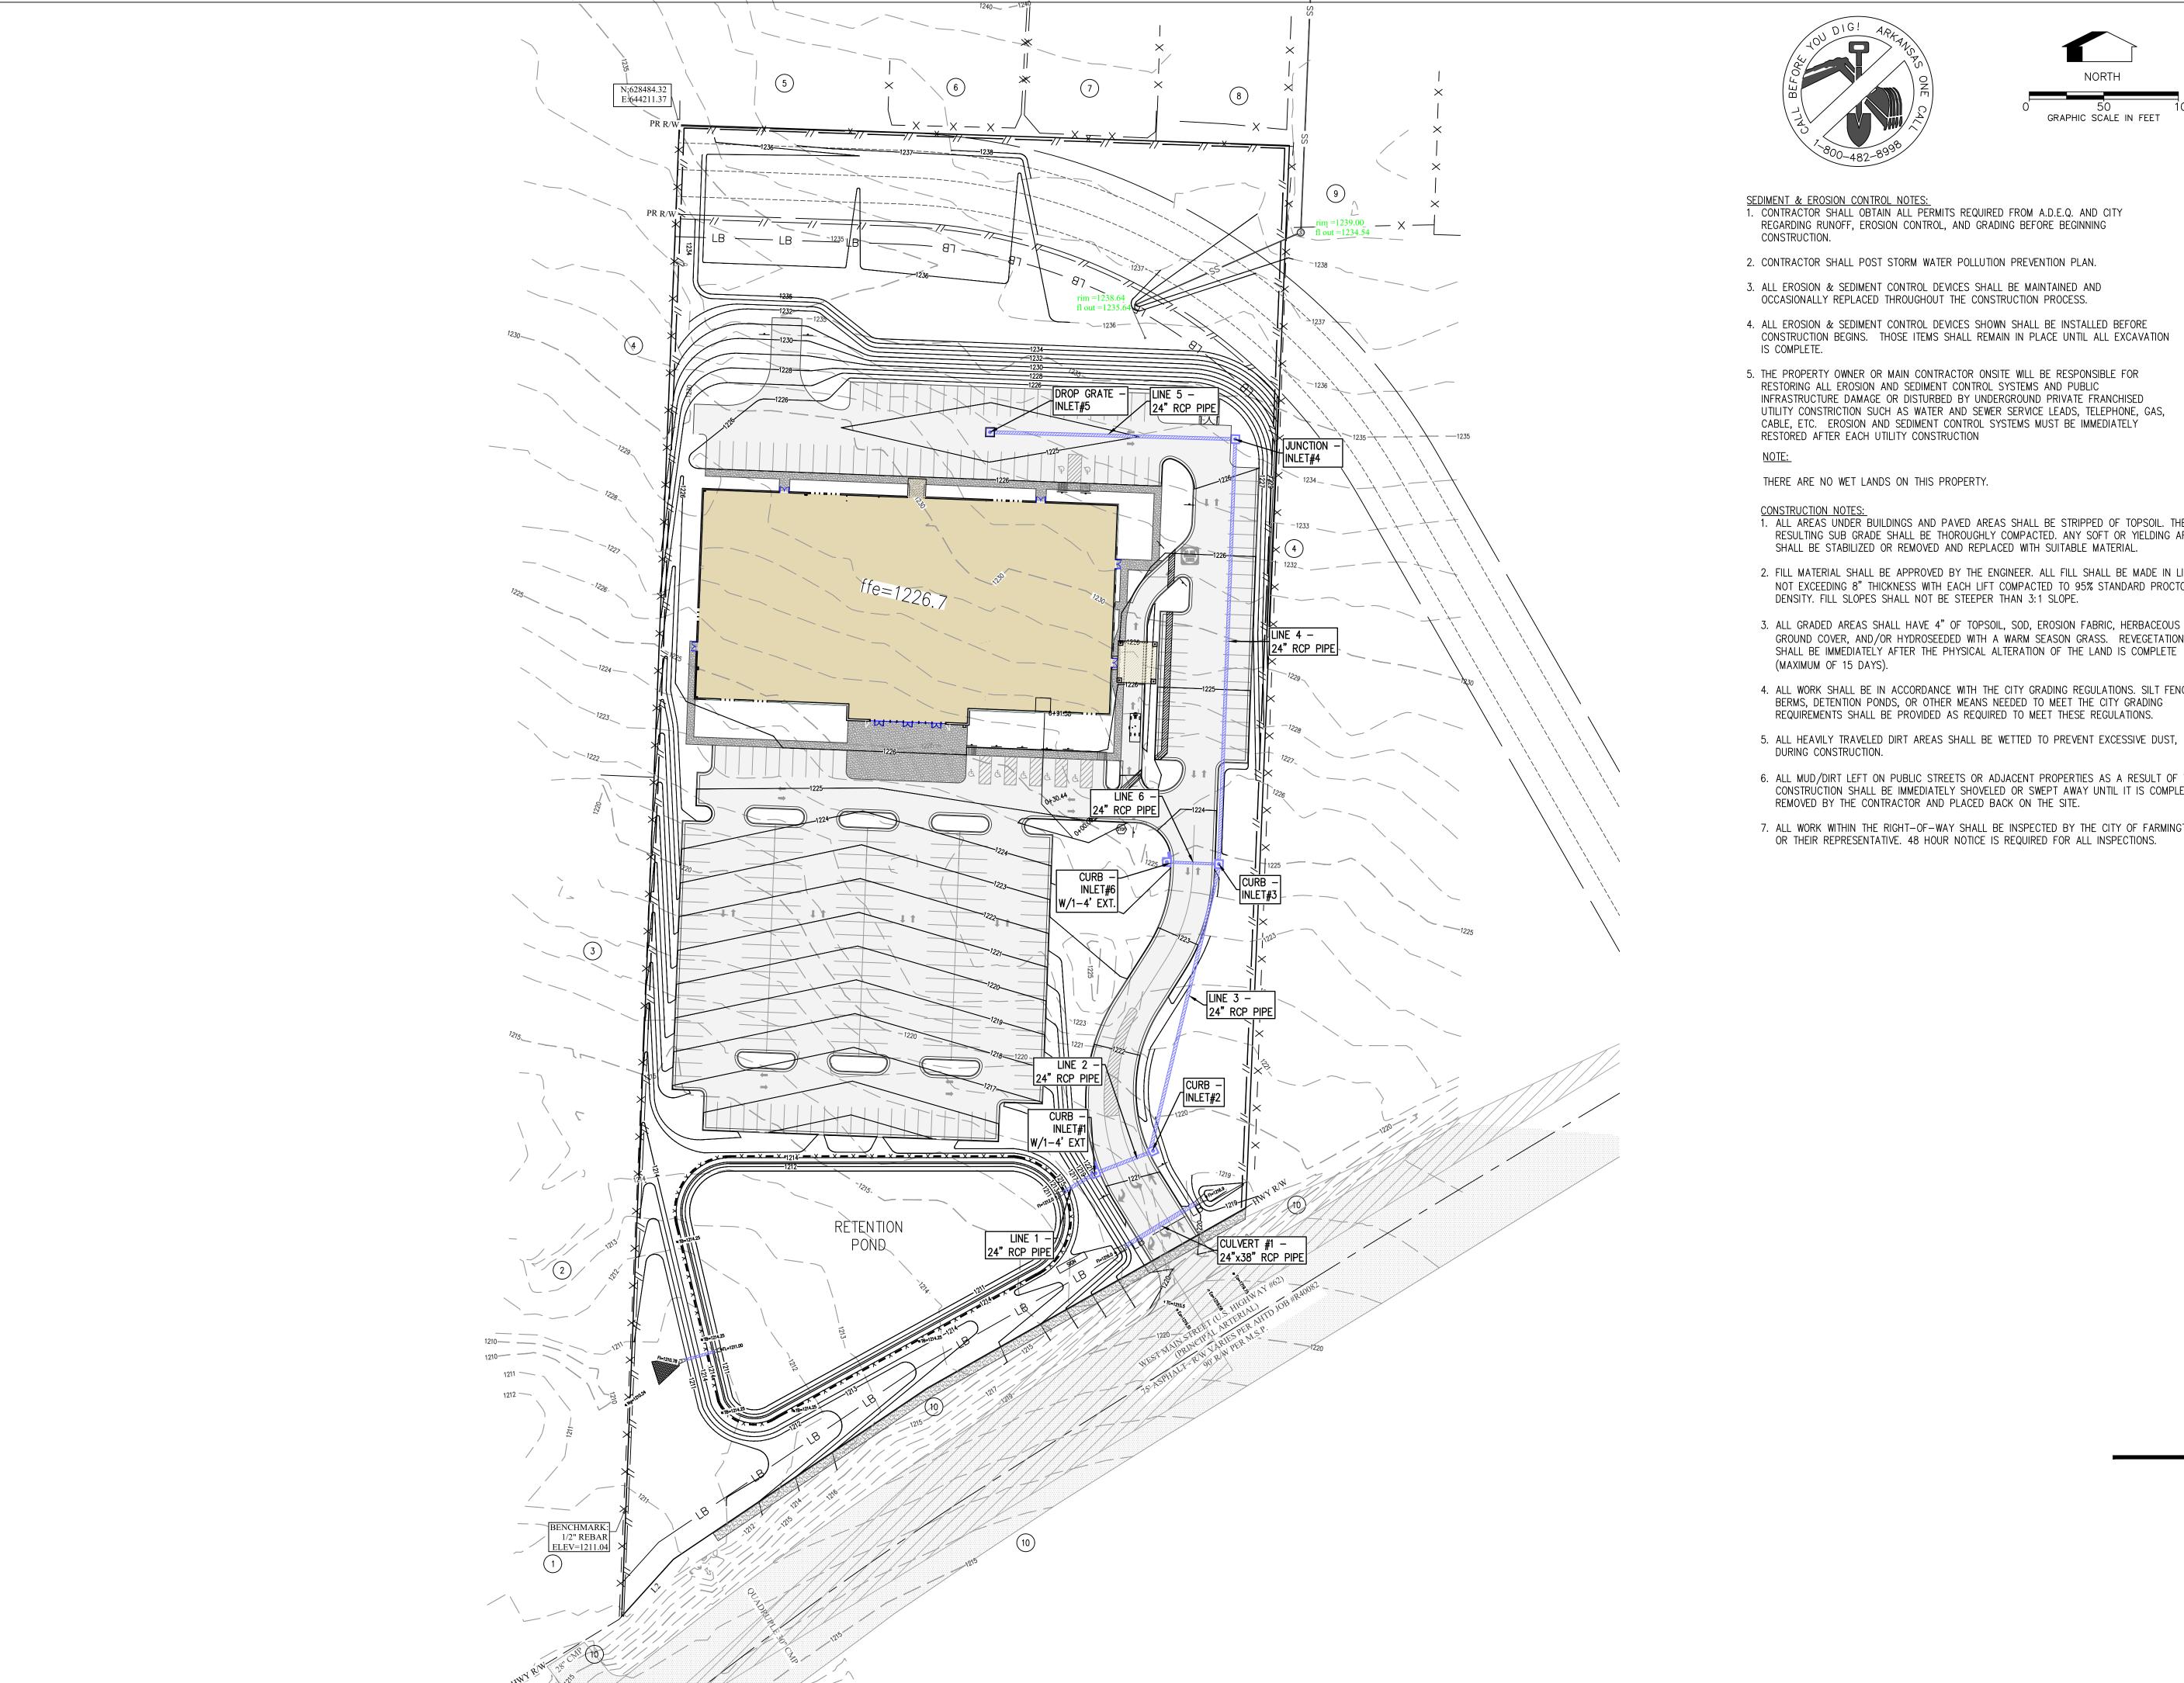



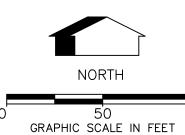

- 1. CONTRACTOR SHALL OBTAIN ALL PERMITS REQUIRED FROM A.D.E.Q. AND CITY REGARDING RUNOFF, EROSION CONTROL, AND GRADING BEFORE BEGINNING
- 2. CONTRACTOR SHALL POST STORM WATER POLLUTION PREVENTION PLAN.
- 3. ALL EROSION & SEDIMENT CONTROL DEVICES SHALL BE MAINTAINED AND OCCASIONALLY REPLACED THROUGHOUT THE CONSTRUCTION PROCESS.
- 4. ALL EROSION & SEDIMENT CONTROL DEVICES SHOWN SHALL BE INSTALLED BEFORE CONSTRUCTION BEGINS. THOSE ITEMS SHALL REMAIN IN PLACE UNTIL ALL EXCAVATION
- 5. THE PROPERTY OWNER OR MAIN CONTRACTOR ONSITE WILL BE RESPONSIBLE FOR RESTORING ALL EROSION AND SEDIMENT CONTROL SYSTEMS AND PUBLIC INFRASTRUCTURE DAMAGE OR DISTURBED BY UNDERGROUND PRIVATE FRANCHISED UTILITY CONSTRICTION SUCH AS WATER AND SEWER SERVICE LEADS, TELEPHONE, GAS, CABLE, ETC. EROSION AND SEDIMENT CONTROL SYSTEMS MUST BE IMMEDIATELY RESTORED AFTER EACH UTILITY CONSTRUCTION

1. ALL AREAS UNDER BUILDINGS AND PAVED AREAS SHALL BE STRIPPED OF TOPSOIL. THE RESULTING SUB GRADE SHALL BE THOROUGHLY COMPACTED. ANY SOFT OR YIELDING AREAS SHALL BE STABILIZED OR REMOVED AND REPLACED WITH SUITABLE MATERIAL.


- 2. FILL MATERIAL SHALL BE APPROVED BY THE ENGINEER. ALL FILL SHALL BE MADE IN LIFTS NOT EXCEEDING 8" THICKNESS WITH EACH LIFT COMPACTED TO 95% STANDARD PROCTOR DENSITY. FILL SLOPES SHALL NOT BE STEEPER THAN 3:1 SLOPE.
- GROUND COVER, AND/OR HYDROSEEDED WITH A WARM SEASON GRASS. REVEGETATION SHALL BE IMMEDIATELY AFTER THE PHYSICAL ALTERATION OF THE LAND IS COMPLETE
- 4. ALL WORK SHALL BE IN ACCORDANCE WITH THE CITY GRADING REGULATIONS. SILT FENCES, BERMS, DETENTION PONDS, OR OTHER MEANS NEEDED TO MEET THE CITY GRADING REQUIREMENTS SHALL BE PROVIDED AS REQUIRED TO MEET THESE REGULATIONS.
- 5. ALL HEAVILY TRAVELED DIRT AREAS SHALL BE WETTED TO PREVENT EXCESSIVE DUST,
- 6. ALL MUD/DIRT LEFT ON PUBLIC STREETS OR ADJACENT PROPERTIES AS A RESULT OF THIS CONSTRUCTION SHALL BE IMMEDIATELY SHOVELED OR SWEPT AWAY UNTIL IT IS COMPLETELY REMOVED BY THE CONTRACTOR AND PLACED BACK ON THE SITE.
- 7. ALL WORK WITHIN THE RIGHT-OF-WAY SHALL BE INSPECTED BY THE CITY OF FARMINGTON OR THEIR REPRESENTATIVE. 48 HOUR NOTICE IS REQUIRED FOR ALL INSPECTIONS.


REGISTERED **PROFESSIONAL ENGINEER** PO No. 9810 BATES & ASSOCIATES, INC. **#**1335

 $\triangleleft$ 

ANS OPMEN CHURCH LARGE



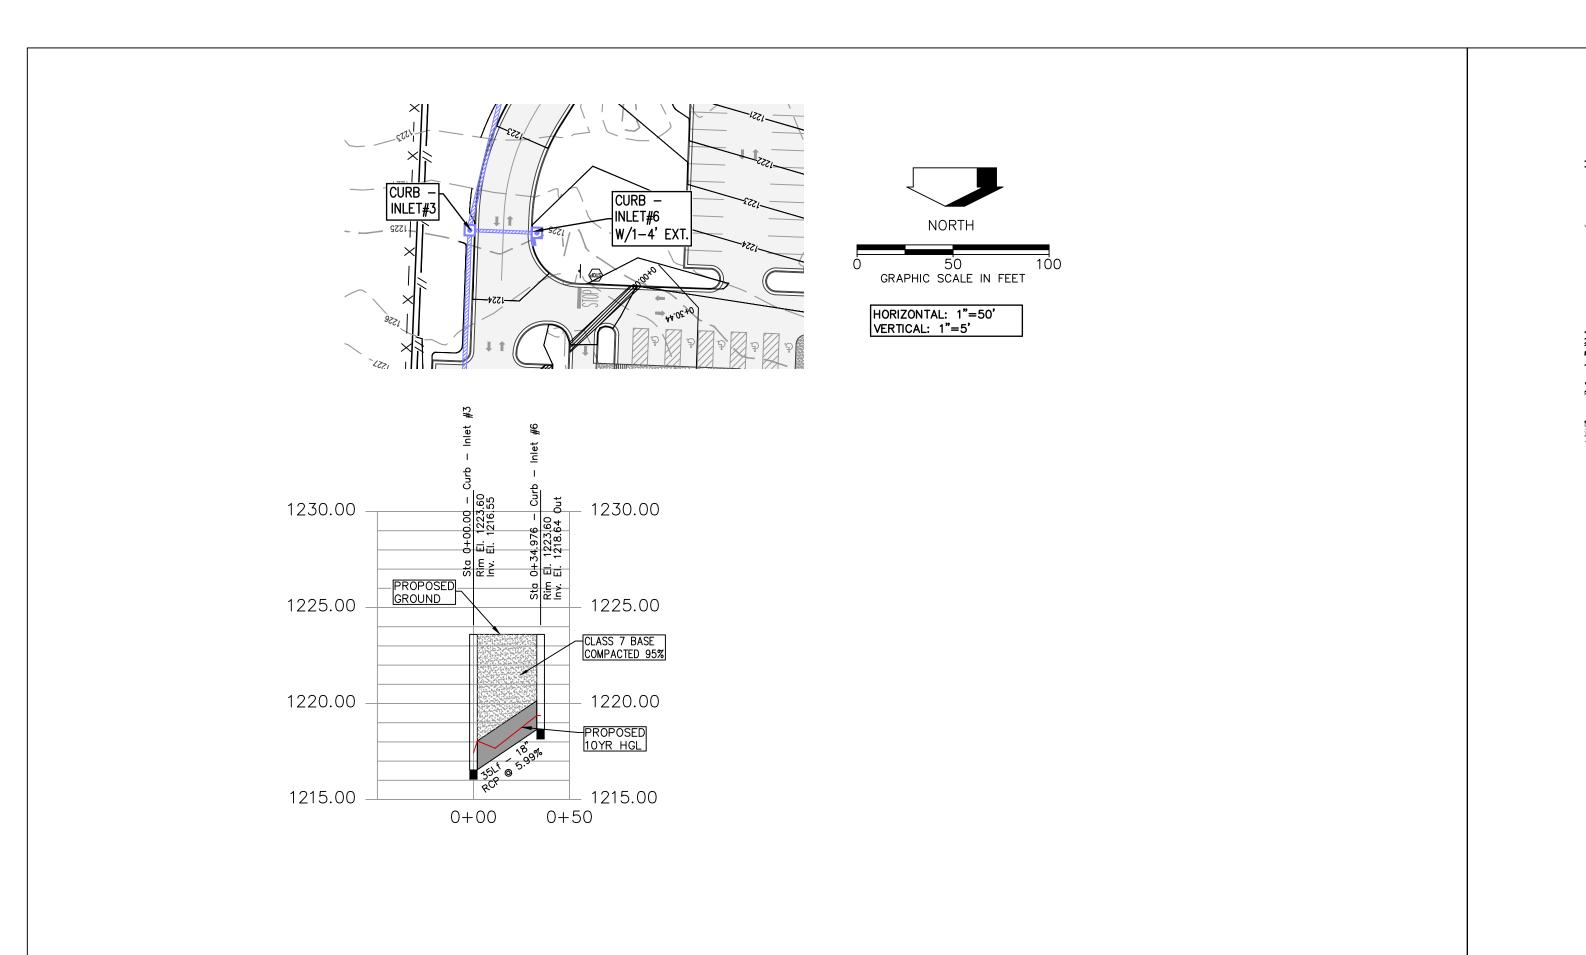

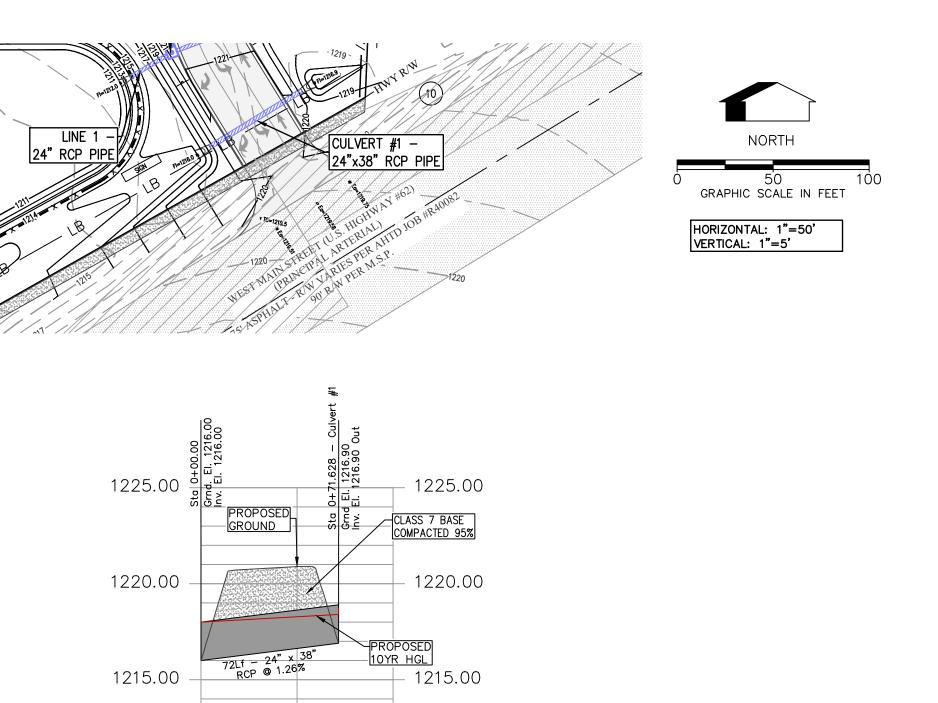

1210.00


1 + 00


0+50


1215.00


1210.00

0+00

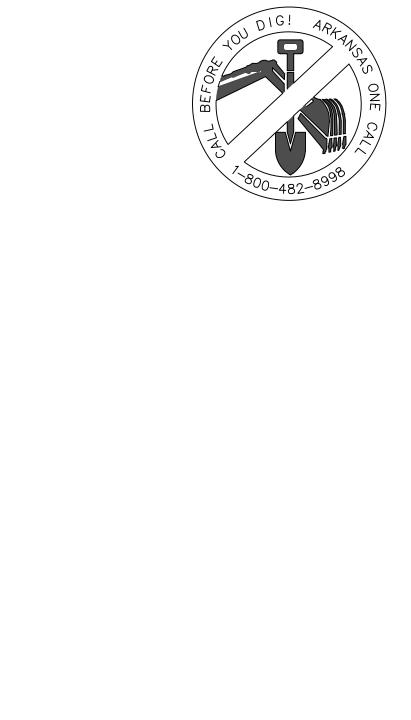

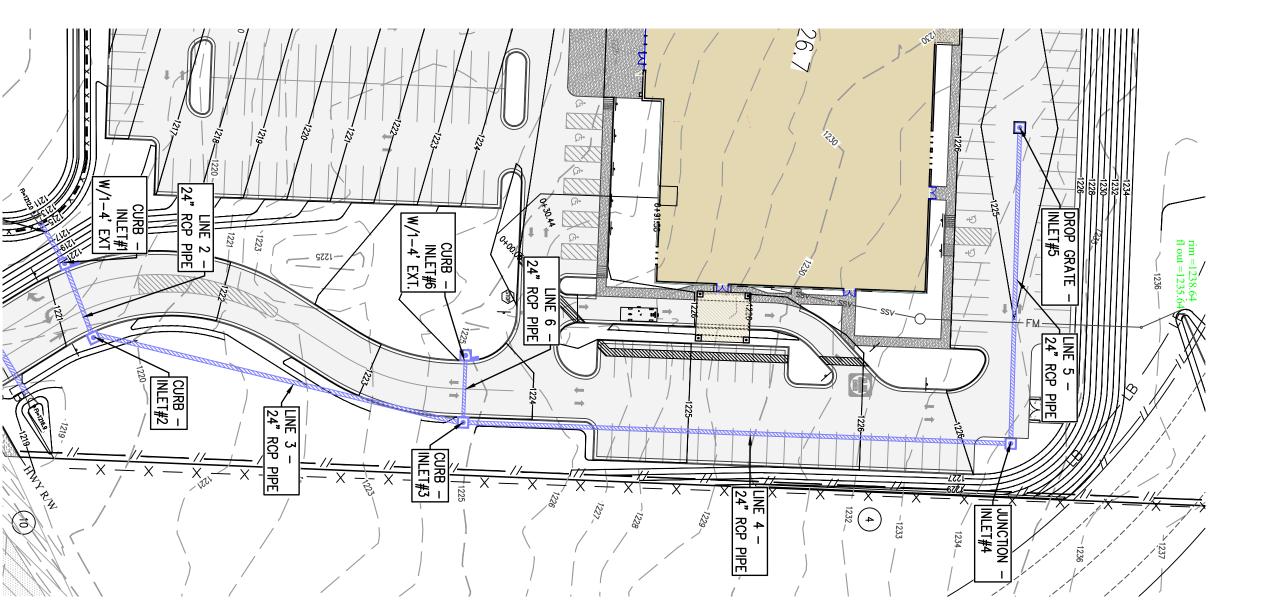

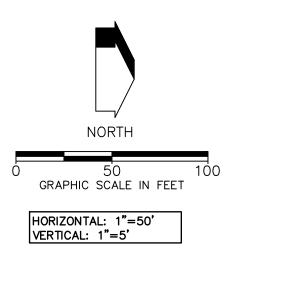

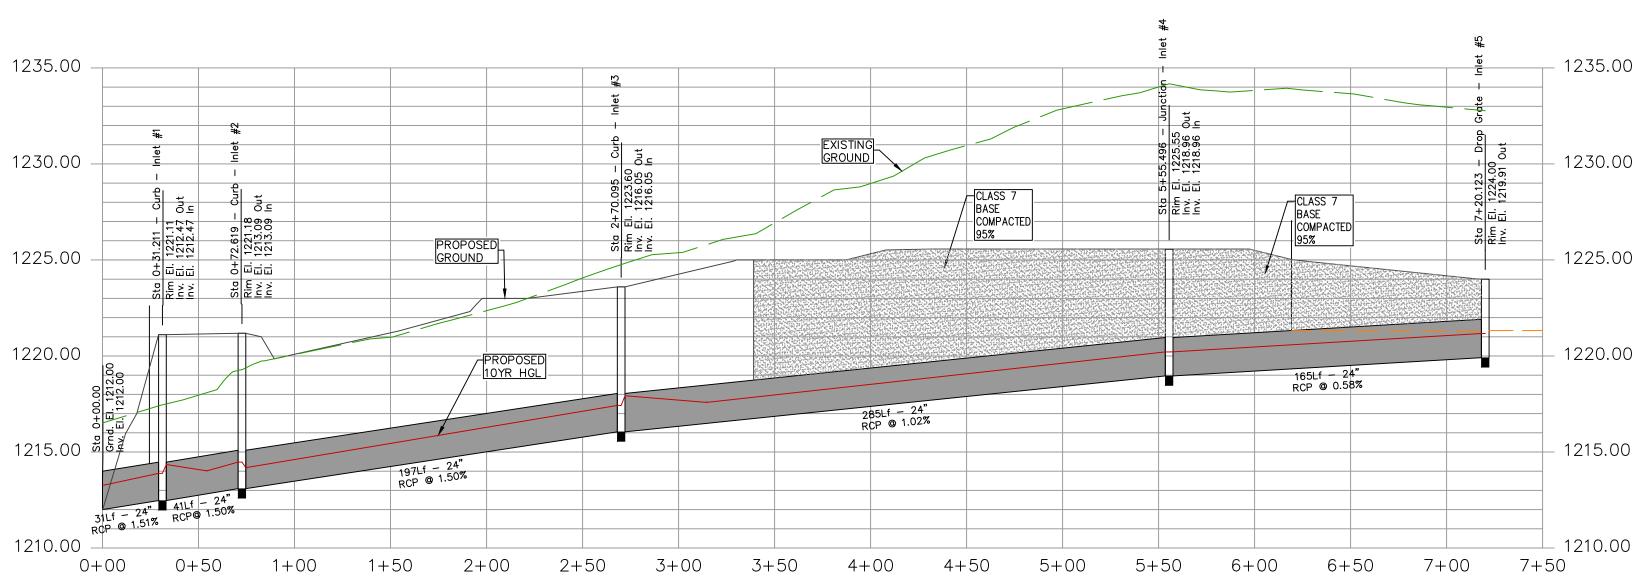

PLANS PLAN — STORM ER PROFILE DEVELOPMENT GRADING PL SEWER BRAND SCALE LARGE

FARMINGTON

ARKANSAS

REGISTERED
PROFESSIONAL
ENGINEER


No. 9810

BATES & ASSOCIATES, INC.

DATE

REVISIONS



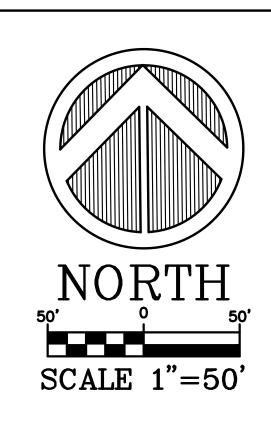

#### GENERAL LANDSCAPE NOTES

- ALL PLANT MATERIALS SHALL ARRIVE AT THE SITE WITH MOIST SOIL.
   CONTRACTORS SHALL HAVE UNDERGROUND UTILITIES LOCATED, LEGIBLY MARKED, AND SHALL REPAIR ANY AND ALL DAMAGE WHICH MAY OCCUR AS A RESULT OF LANDSCAPE INSTALLATION. UTILITIES SHOWN ON THIS PLAN ARE APPROXIMATED, AND SHOULD BE VERIFIED ON THE CIVIL UTILITY PLAN AND IN THE FIELD.
- APPOXIMATED, AND SHOULD BE VERIFIED ON THE CIVIL OTTLITY PLAN AND IN THE FIELD.
   UNDER NO CIRCUMSTANCES WILL LANDSCAPE WORK BE APPROVED FOR PAYMENT IF PLANT SIZE AND GENERAL HEALTH ARE NOT AS REQUIRED ON PLAN.
   ALL PLANTS MUST BE CONTAINER GROWN OR BALLED AND BURLAPPED AS INDICATED ON PLANT LIST.
   ALL TREES MUST BE STRAIGHT TRUNKED, FULL HEADED AND MEET ALL REQUIREMENTS AS SPECIFIED.
- 6. ALL PLANTS ARE SUBJECT TO THE APPROVAL OF THE LANDSCAPE ARCHITECT AND THE OWNER BEFORE, DURING AND AFTER INSTALLATION.

  7. THE LANDSCAPE ARCHITECT MUST APPROVE ANY ALTERATIONS OR REVISIONS TO THE LANDSCAPE PLAN.

  8. THE CONTRACTOR SHALL PROTECT EXISTING FEATURES ON SITE.
- 9. ALL DISTURBED LANDSCAPED AREAS NOT DESIGNATED TO BE SODDED SHALL BE SEEDED WITH A GRASS SEED MIX OF 75%
- ALL DISTURBED LANDSCAPED AREAS NOT DESIGNATED TO BE SOUDED SHALL BE SEEDED WITH A GRASS SEED MIX OF 78 PERINNIAL RYE AND 25% BERMUDA GRASS SEED AT A RATE OF 4# PER 1000 SF.
   THE LANDSCAPE CONTRACTOR SHALL VERIFY ALL QUANTITIES SHOWN ON THESE PLANS, BEFORE PRICING THE WORK.
   THE LANDSCAPE CONTRACTOR SHALL FULLY MAINTAIN ALL PLANTING (INCLUDING BUT NOT LIMITED TO WATERING, SPRAYING, MULCHING, FERTILIZING, ETC.) OF PLANTING AREAS AND LAWNS FOR 90 DAYS AFTER SUBSTANTIAL
- SPHATING, MULCHING, FERTILIZING, ETC.) OF PLANTING AREAS AND LAWNST ON SO DATS AT LET SOCIETATION.

  12. ONCE INSTALLED, LANDSCAPING SHALL BE MAINTAINED IN HEALTHY LIVING CONDITION AND ALL PLANT MATERIAL THAT DIES SHALL BE REPLACED.

  13. HEALTHY TREES SHALL NOT BE REMOVED AT ANY TIME AND PROPER TREE PRUNING TECHNIQUES AS ESTABLISHED BY THE LATEST EDITION OF ANSI A300 "STANDARDS FOR TREE CARE" SHALL BE UTILIZED FOR MAINTENANCE PURPOSES.
- 14. THE GENERAL CONTRACTOR IS RESPONSIBLE FOR FINISHED GRADING ALL LANDSCAPE PARKING ISLANDS. FINISHED GRADE IN ISLANDS IS TO BE CROWNED APPROXIMATELY 12"-18" ABOVE THE TOP OF CURB. SOIL IN ISLANDS IS TO BE FREE OF
- UNSUITABLE MATERIAL AND DEBRIS I.E. GRAVEL OR ASPHALT.

  15. IF CONTRACTOR IS UNABLE TO DIG PLANT PITS TO A DEPTH THAT WILL PROVIDE THE AREA OF SOIL AROUND THE ROOT BALL DUE TO ROCK, CONTACT ARCHITECT, CIVIL ENGINEER, AND CITY HORTICULTURIST IMMEDIATELY.
- 16. NO PROPOSED IRRIGATION SYSTEM HOSE BIBS ARE LOCATED ON THE EXTERIOR WALLS OF THE BUILDING AND ARE
- 10. NO PROPOSED INRIGATION STSTEM HOSE BIBS ARE LOCATED ON THE EXTERIOR WALLS OF THE BUILDING AND ARE WITHIN 100' OF ALL PLANT MATERIAL.
  17. ALL PROPOSED TREES SHALL BE A MINIMUM OF 5' FROM ALL PUBLIC UTILITIES.
  18. TREES SHALL NOT BE TOPPED AT ANY TIME AND PROPER TREE PRUNING TECHNIQUES AS ESTABLISHED BY THE LATEST EDITION OF ANSI A300 "STANDARDS FOR TREE CARE" SHALL BE UTILIZED FOR MAINTENANCE PURPOSES.
- 19. THERE CANNOT BE ANYTHING BETWEEN 3' AND 8' IN HEIGHT WITHIN THE SIGHT TRIANGLE.

#### LANDSCAPE REQUIREMENTS

TOTAL SITE AREA:

STREET BUFFER FRONTAGE LENGTH: STREET TREES REQUIRED: STREET TREES PROVIDED: SHRUBS REQUIRED: STREET TREES PROVIDED:

WEST SIDE PERIMETER BUFFER BUFFER TREES REQUIRED:

**BUFFER TREES PROVIDED:** SHRUBS REQUIRED: STREET TREES PROVIDED: 6' OPAQUE WOODEN FENCE

EAST SIDE PERIMETER BUFFER BUFFER TREES REQUIRED: **BUFFER TREES PROVIDED:** 

SHRUBS REQUIRED: STREET TREES PROVIDED: 6' OPAQUE WOODEN FENCE

NORTH SIDE PERIMETER BUFFER **BUFFER TREES REQUIRED: BUFFER TREES PROVIDED:** SHRUBS REQUIRED: STREET TREES PROVIDED: 6' OPAQUE WOODEN FENCE

FOUNDATION PLANTINGS 25% OF FRONT BUILDING FACADE SHALL HAVE LANDSCAPING

PARKING LOT LANDSCAPING 1 TREE PER LANDSCAPED ISLAND 60% SCREENING AT ADJACENT RESIDENTIAL LOTS REQUIRED

\*TOTAL INCLUDES EXISTING TREES

345,300 SF

14 TREES (1 PER 35 LF OF FRONTAGE, 498 LF TOTAL) 14 TREES 43 SHRUBS (1 PER 35 LF OF FRONTAGE, 498 LF TOTAL)

76 SHRUBS PROVIDED 29 TREES (1 PER 35 LF OF PERIMETER, 1,002 LF TOTAL)

29 TREES 86 SHRUBS (1 PER 35 LF OF PERIMETER, 1,002LF TOTAL) 86 SHRUBS PROVIDED WOOD FENCE PROVIDED

20 TREES (1 PER 35 LF OF PERIMETER, 714 LF TOTAL) 20\* TREES

61 SHRUBS (1 PER 35 LF OF PERIMETER, 714 LF TOTAL)

98 SHRUBS PROVIDED 6' FENCE PROVIDED

12 TREES (1 PER 35 LF OF PERIMETER, 409 LF TOTAL) 12 TREES


35 SHRUBS (1 PER 35 LF OF PERIMETER, 409 LF TOTAL) 35 SHRUBS PROVIDED 6' FENCE PROVIDED

25% LANDSCAPING PROVIDED

1 TREE PER ISLAND PROVIDED

SCREENING PROVIDED




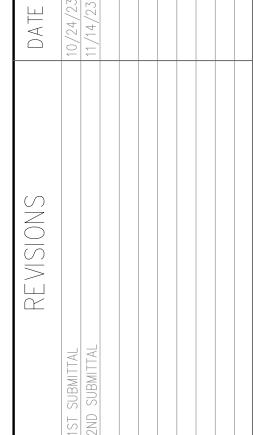



CHURCH OPMENT | > 뮏 DE BRAND ARGE




L - 100

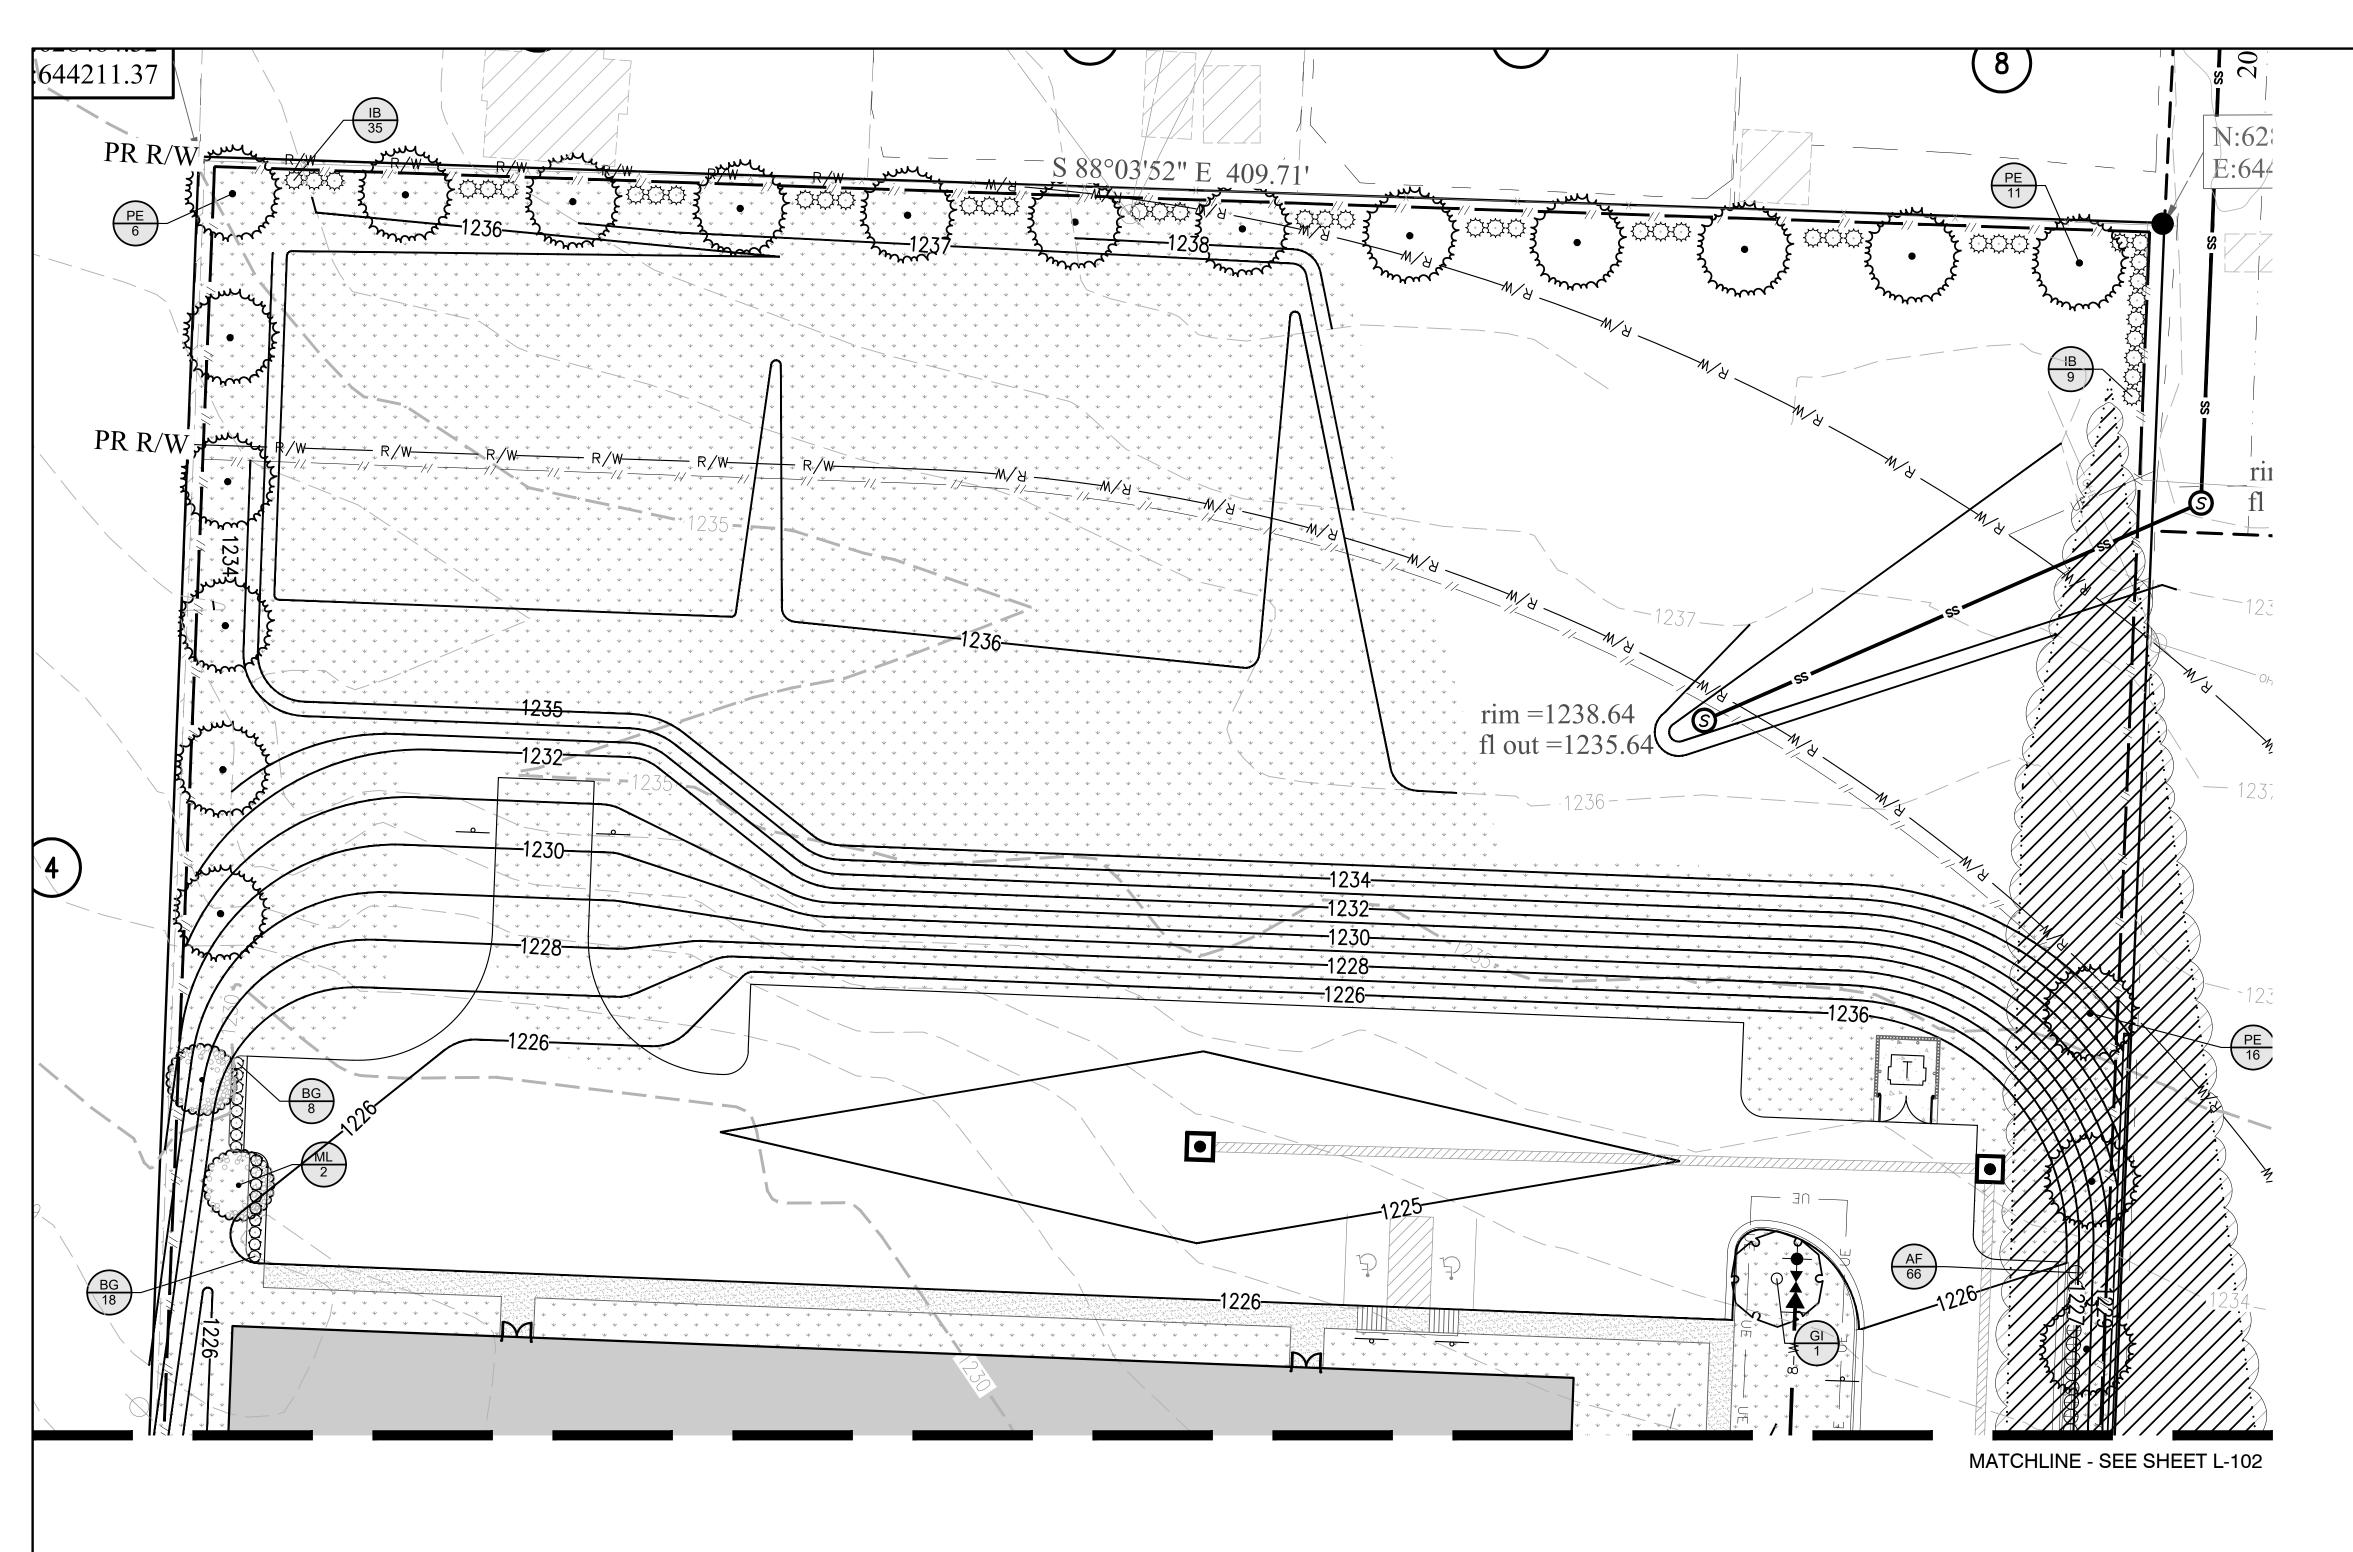

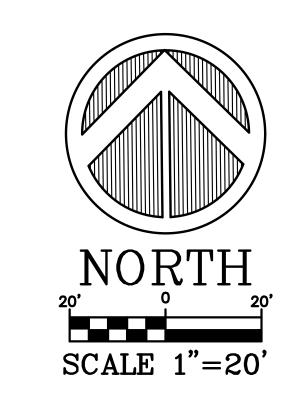

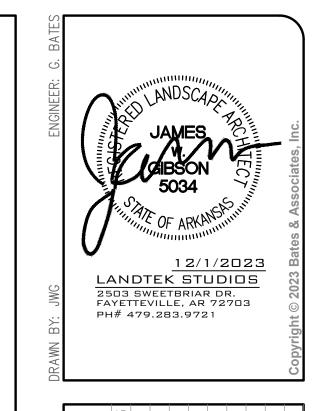

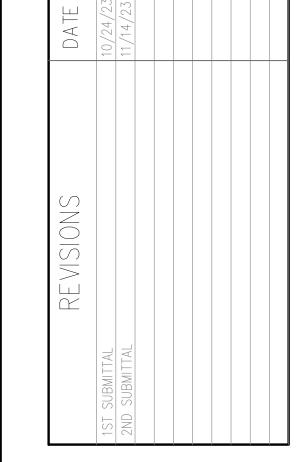


DEVELOPMENT ANDSCA BRAND SCALE [


**ARKANSAS** 

FARMINGTON

L-101

PLANT SCHEDULE													
SYMBOL	CODE	BOTANICAL / COMMON NAME	CALIPER	ROOT	HEIGHT	<u>QTY</u>	SYMBOL	CODE	BOTANICAL / COMMON NAME	SIZE	CONTAINER	SPACING	QTY
EVERGREEN TREES SHRUBS													
	<b>.</b>	Married Committee of the committee of th						AF	Abelia x grandiflora `Francis Mason` / Francis Mason Abelia	3 gal.	Cont.	36" o.c.	114
	ğ ML	Magnolia grandiflora 'Little Gem' / Little Gem Dwarf Southern Magnolia	1 2.5" Cal.	B&B or Cont.	8` min.	15		BG	Buxus x `Green Mound` / Green Mound Boxwood	3 gal	Cont.	30" o.c.	26
Julian Contraction of the Contra	ć.							IB	llex cornuta 'Burfordii Nana' / Dwarf Burford Holly	3 gal	Cont.	48" o.c.	184
*	PE PE	Pinus echinata / Short Leaf Pine	2.5" Cal.	B&B or Cont.	8` min.	42	£ + 3	IH	llex crenata 'Helleri' / Heler Japanese Holly	3 gal	Cont.	36" o.c.	54
yrrency	ζ.							TD2	Thuja occidentalis 'Degroot's Spire' / Degroot's Spire Arborvitae	5 gal	Cont.	48" o.c.	8
SHADE TREI	<u>ES</u>						SYMBOL	CODE	BOTANICAL / COMMON NAME				QTY
	ر GI	Gleditsia triacanthos inermis 'Skycole' / Skyline® Honey Locust	2.5" Cal.	B&B or Cont.	8` min.	18	SOD/SEED						
~ ~	J	and and an action of the state	2.5 <b>J</b> ai.	Bab of Cont.	o min.	10	,		Cynodon dactylon `Tif 419` / Bermuda Grass				153,712 sf
							/ \\ \\ \\ \\ \\	`					

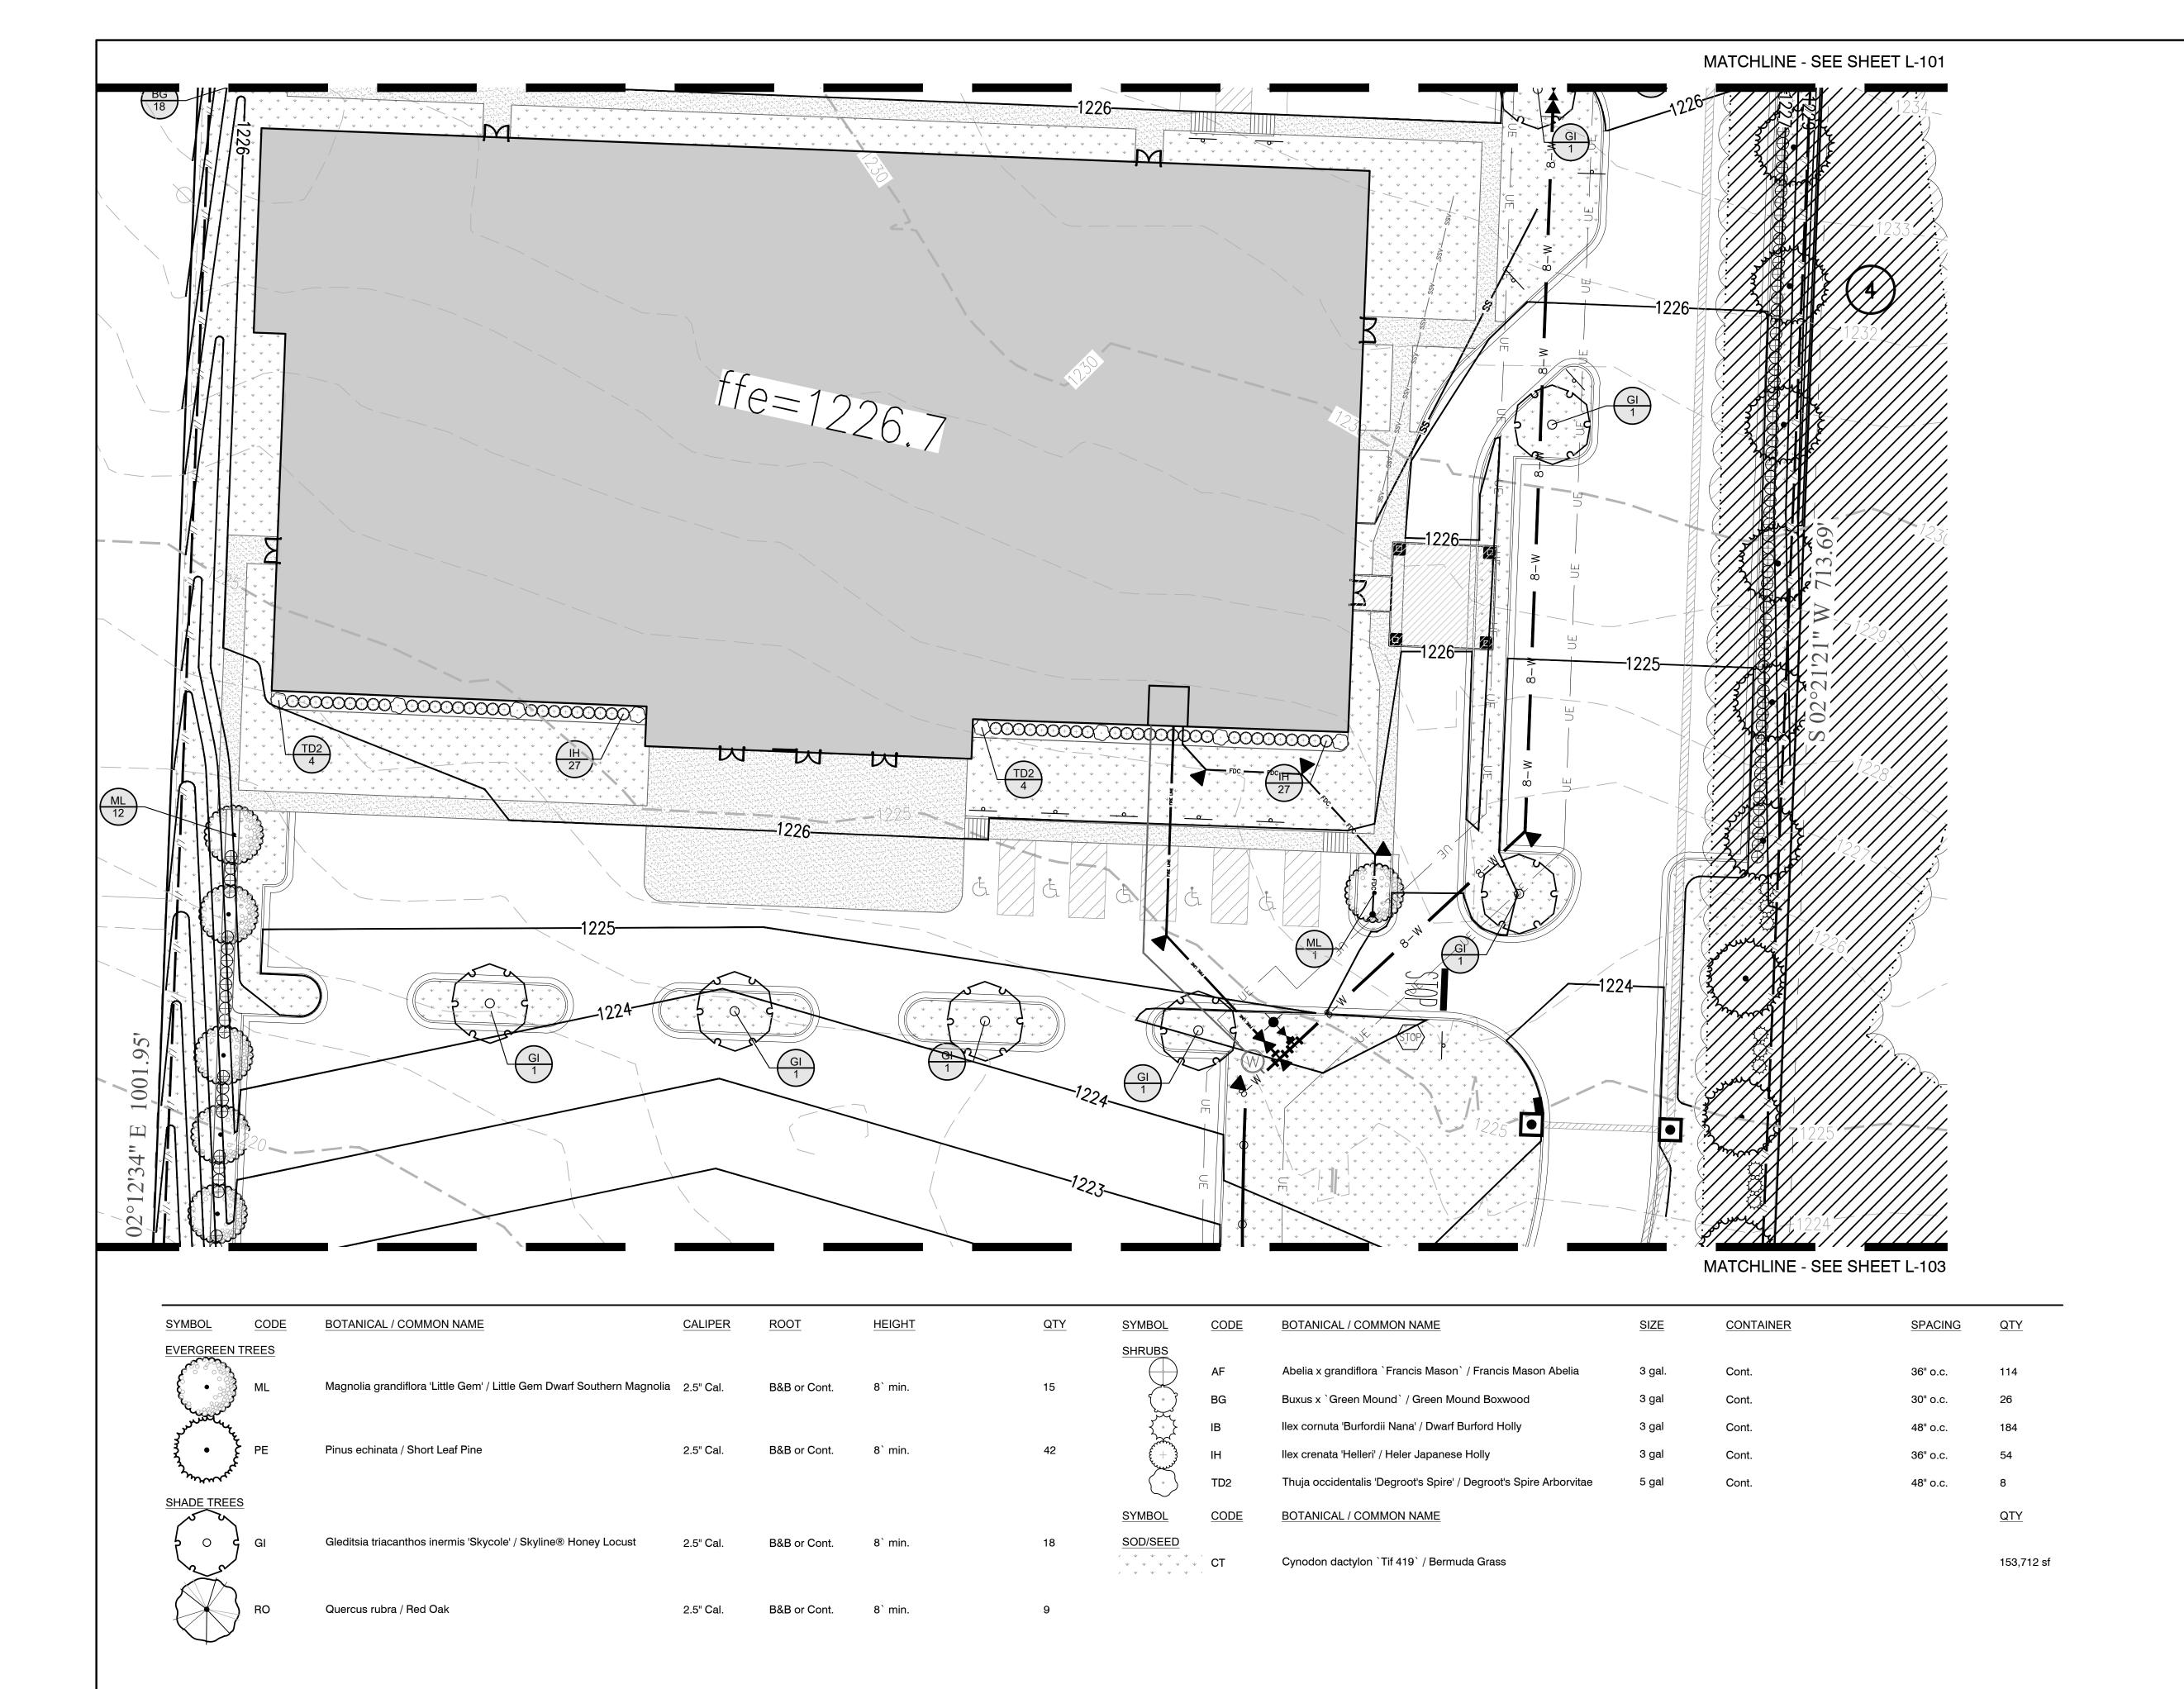

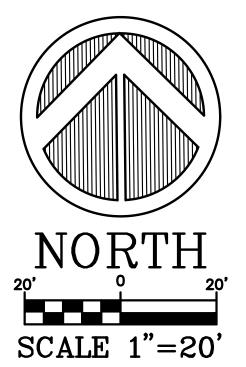




W CHURCH NE/ DEV ANDSC, BRAND SCALE I LARGE

ARMINGTON


Engineers


DRAWING NO.

L-102

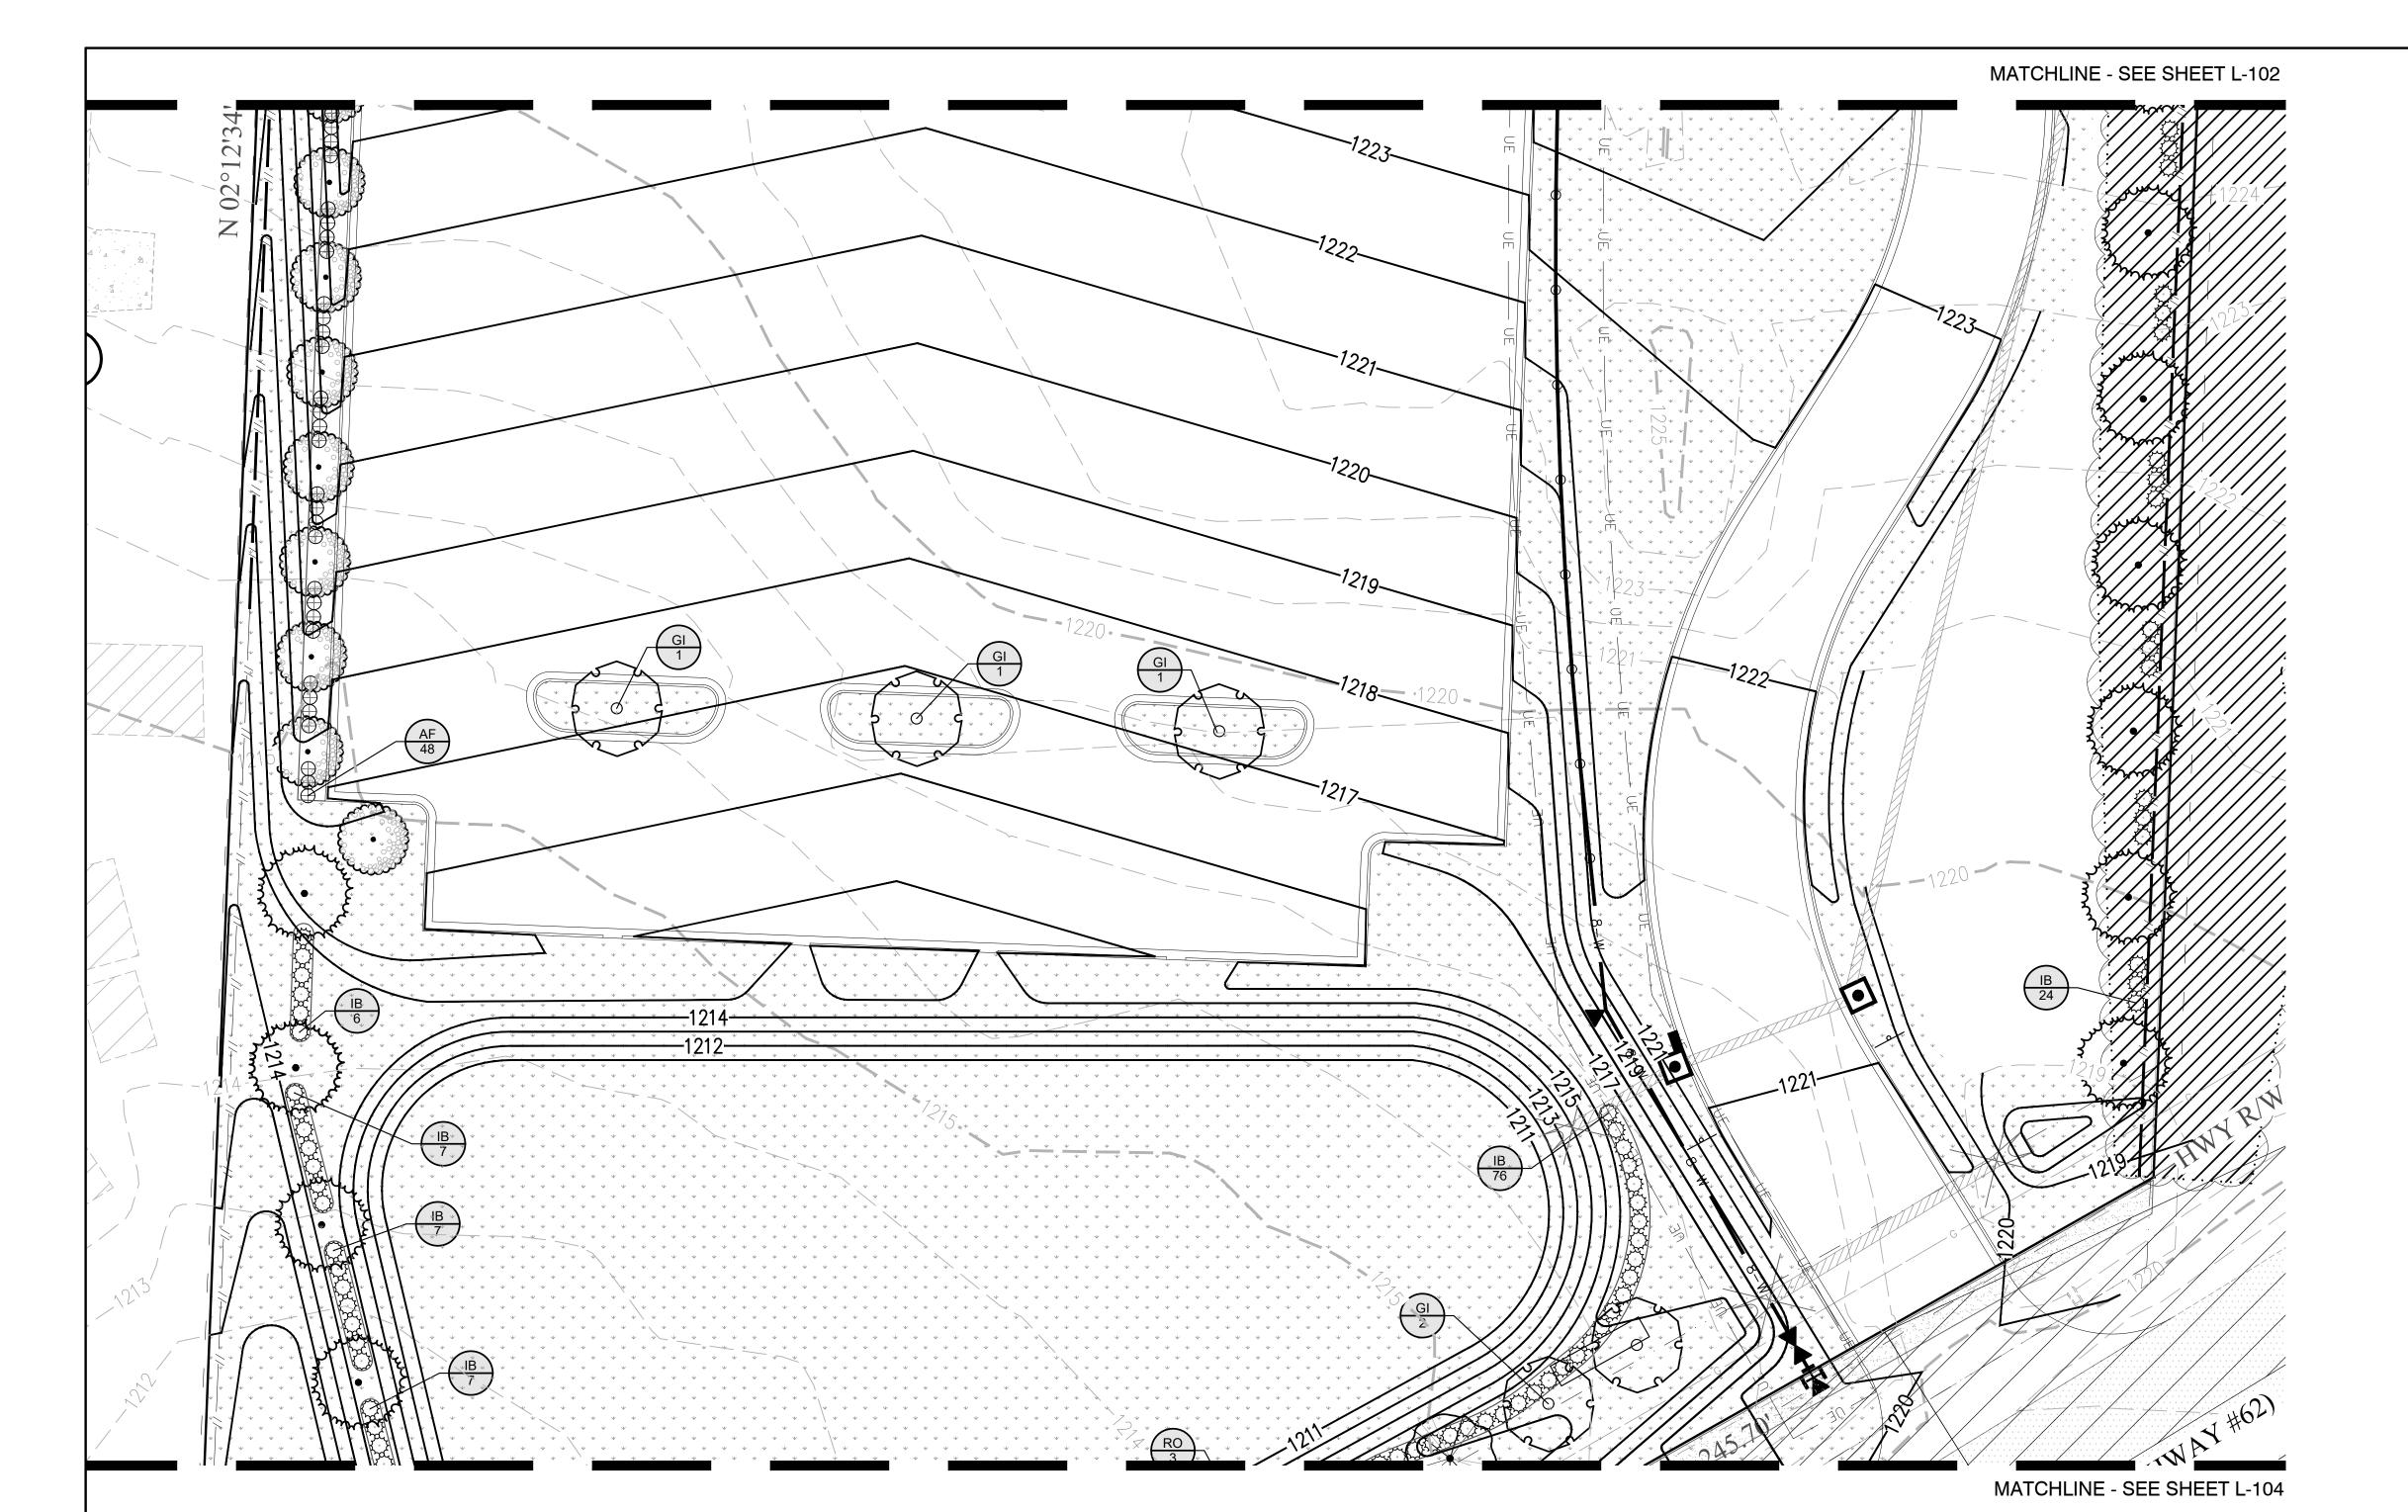



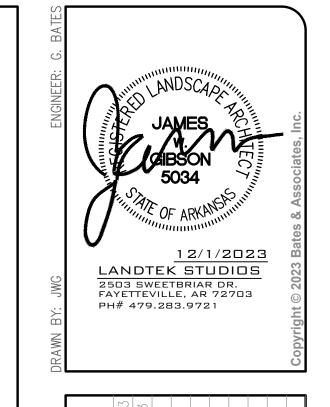

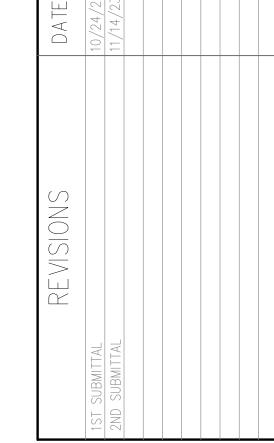

CHURCH **ELOPMENT** ANDSCA NE/ DEV BRAND SCALE [ LARGE


**FARMINGTON** 


Engineers
7230 S Pleasant Ridge [


DRAWING NO. L-103


B&B or Cont. 8` min.

Quercus rubra / Red Oak

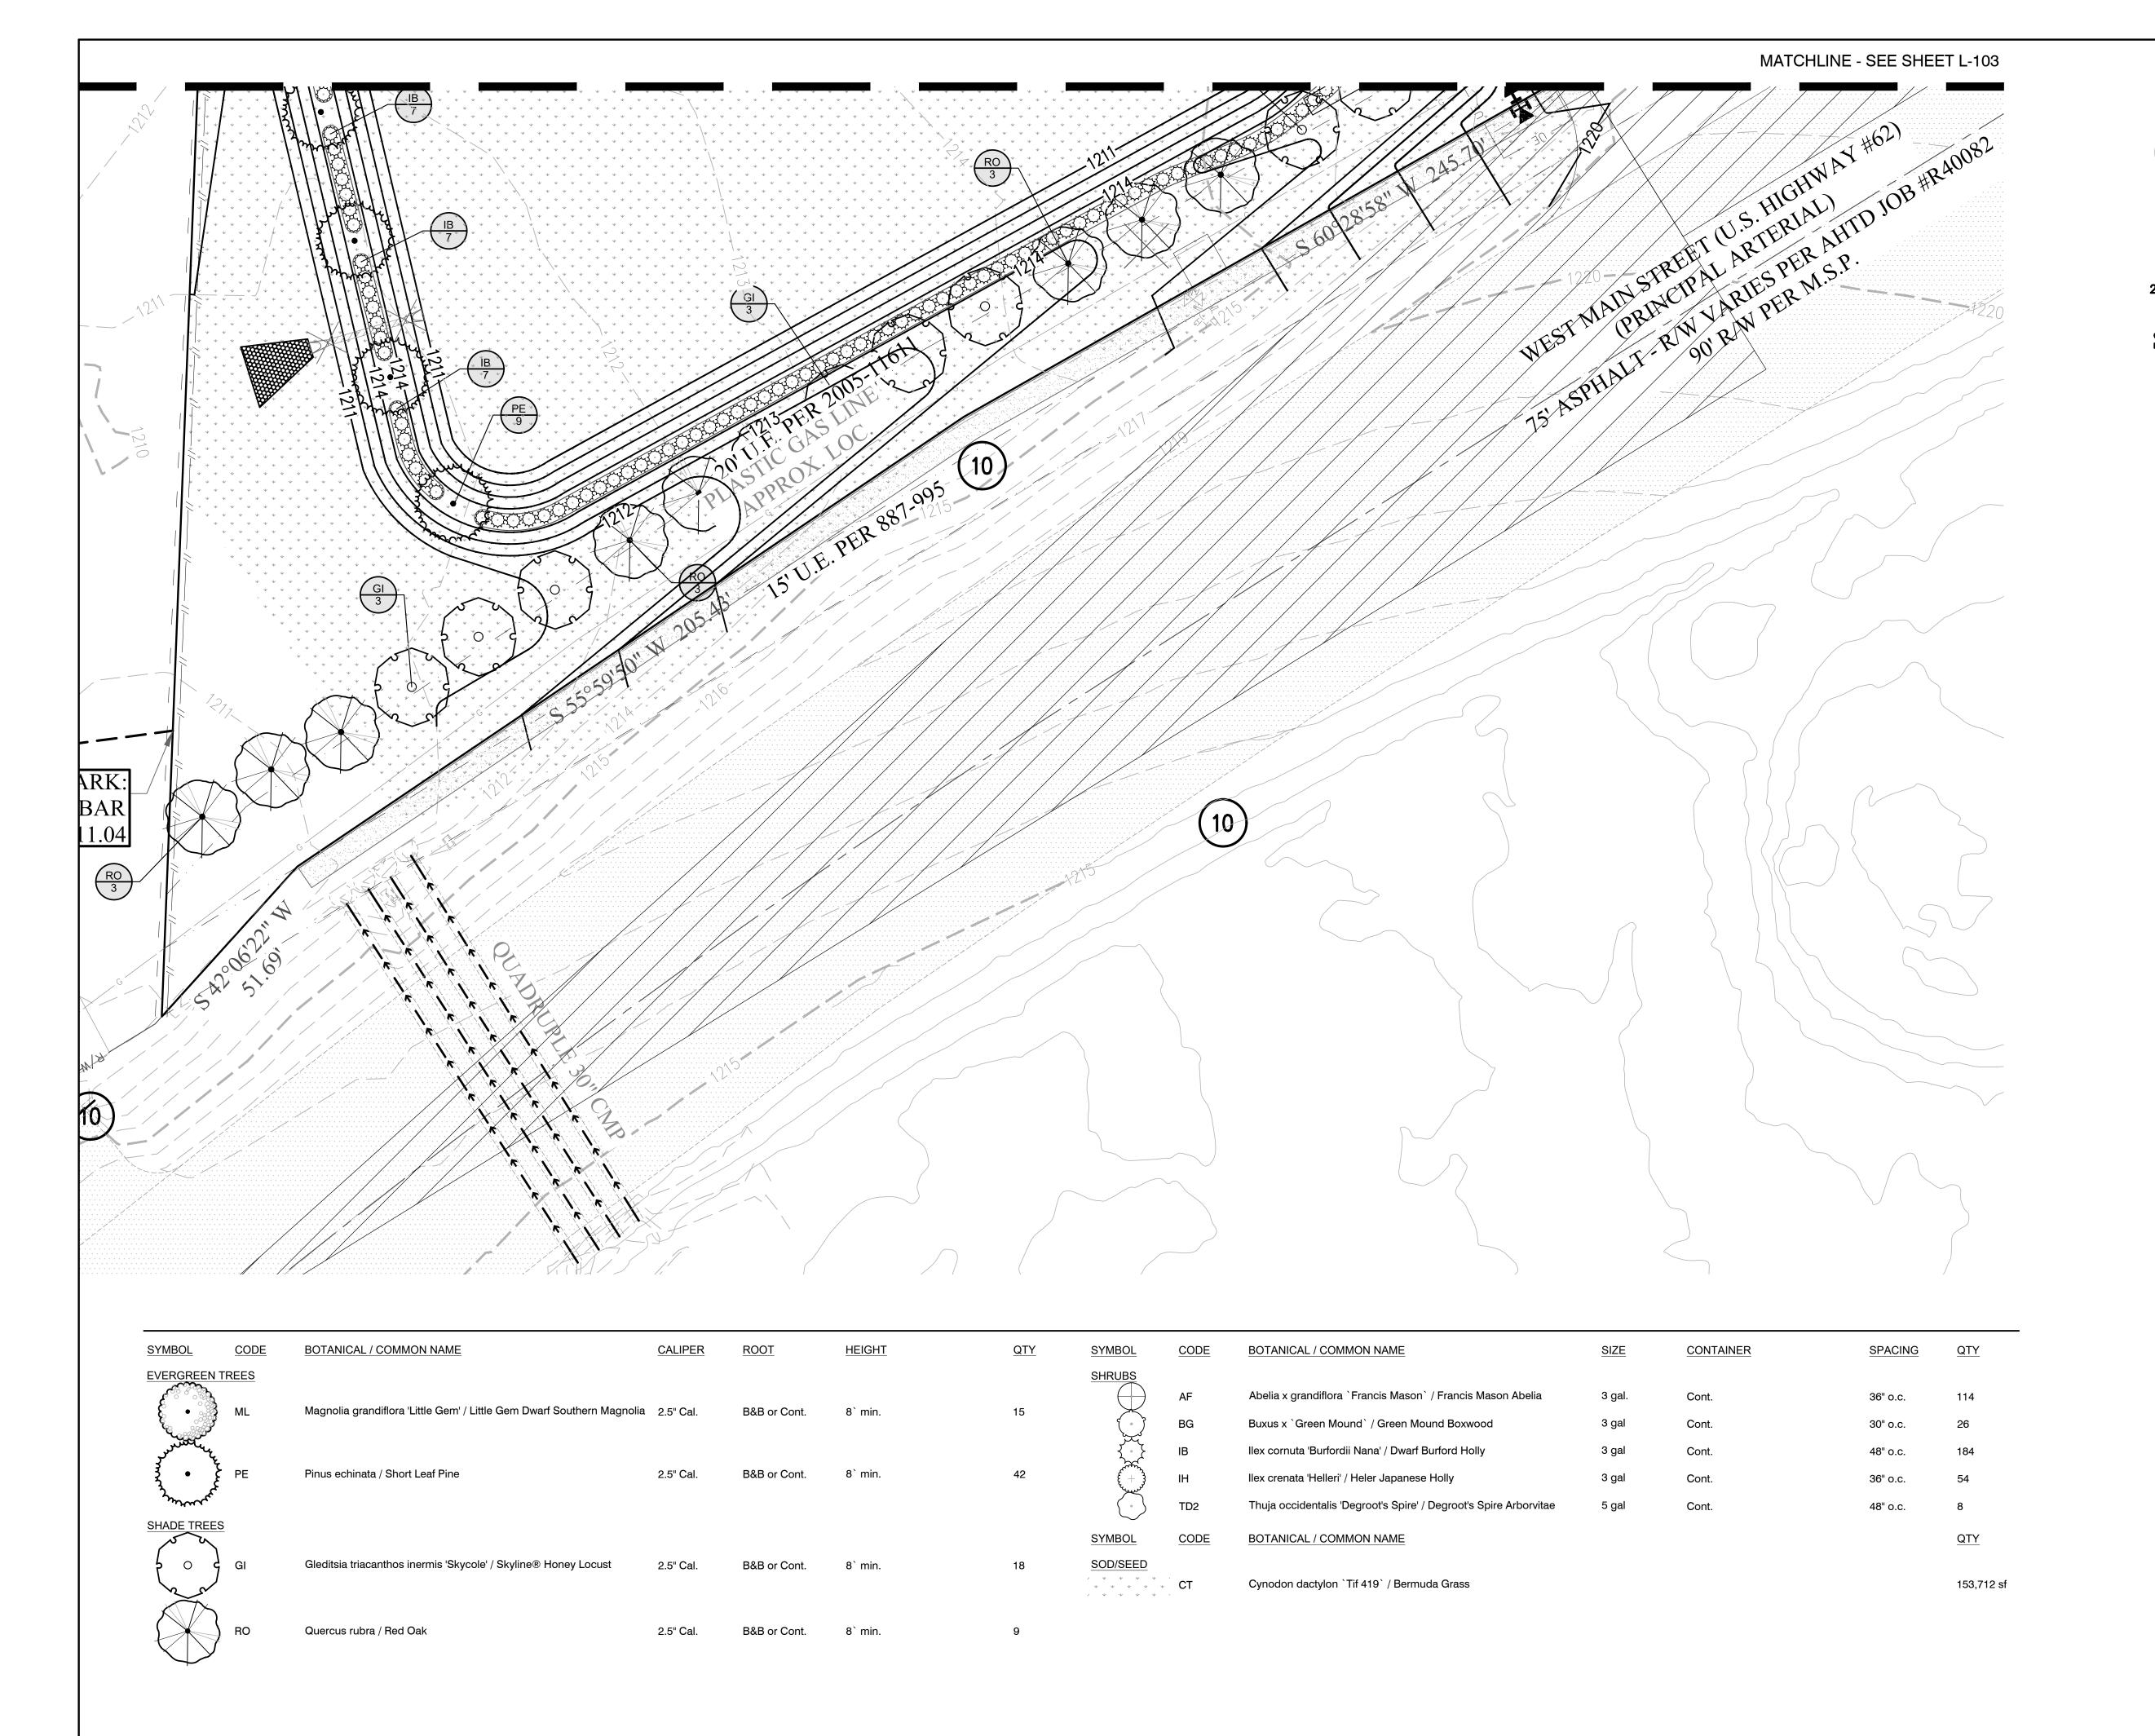

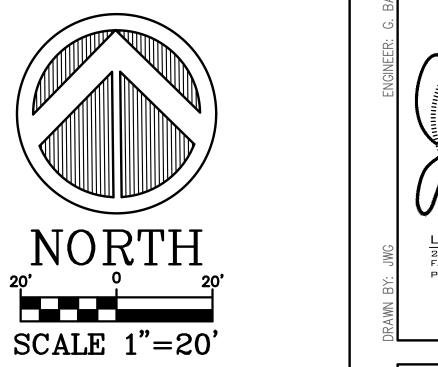

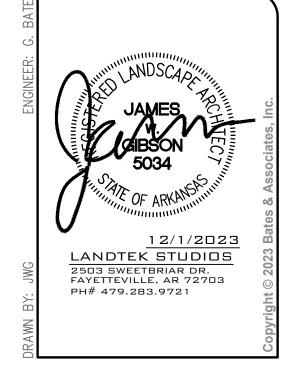

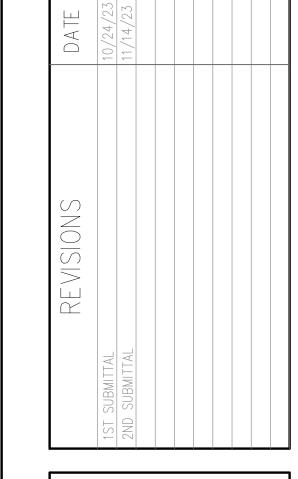


**PLANS** CHURCH **FLOPMENT** BRAND NEW SCALE DEVEL ANDSC/ LARGE

**ARKANSAS** 

ARMINGTON

Engineers
7230 S Pleasant Ridge [



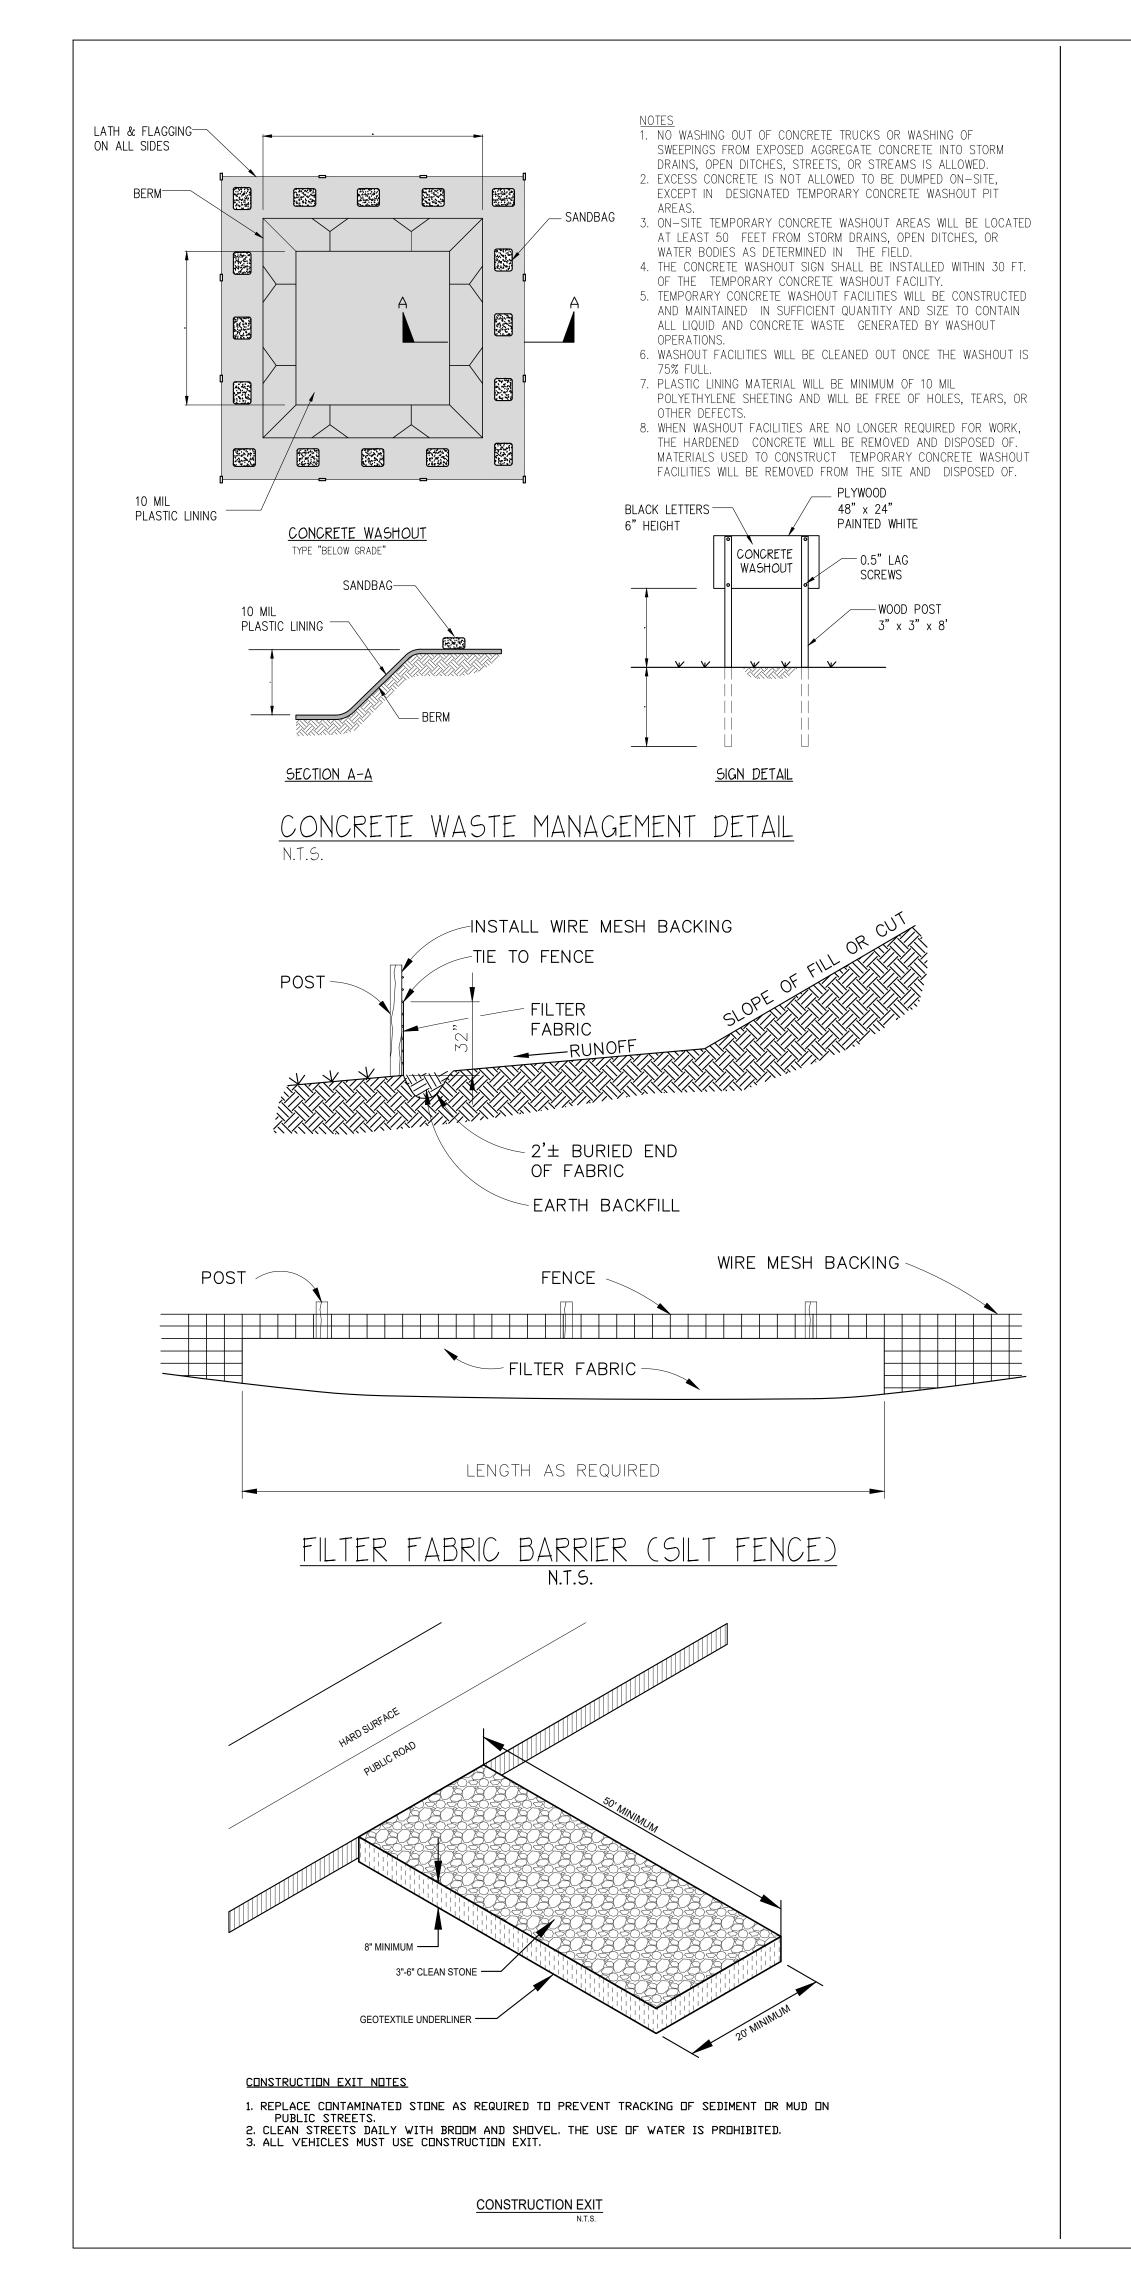


#### SIDEWALK NOTES


ALL SIDEWALK SHALL BE CONSTRUCTED OF PORTLAND CONCRETE WITH A MINIMUM 28 DAY COMPRESSIVE STRENGTH OF 3,500 PSI WHEN TESTED. ALL CONCRETE SHALL CONTAIN AN AIR ENTRAINING AGENT WHICH PRODUCES FIVE PERCENT PLUS OR MINUS TWO PERCENT AIR ENTRAINMENT IN THE CONCRETE.


EXPANSION JOINTS SHALL BE PROVIDED AT 25 FOOT INTERVALS, AT ALL STATIONARY STRUCTURES SUCH AS DROP INLETS, AND AT CURB RETURNS. JOINT MATERIAL SHALL HAVE A THICKNESS OF ONE-HALF INCH AND CONFORM TO AASHTO M 213 STANDARDS.

SIDEWALKS MUST HAVE CONTRACTION JOINTS SAWED EVERY 5 FEET ON CENTER, AND SHALL BE SAWED TO A DEPTH OF  $1\frac{1}{2}$ " WITH A WIDTH OF  $\frac{1}{4}$ ". MATERIAL USED TO SEAL JOINTS SHALL BE AS SPECIFIED IN SECTION 501 AHTD STANDARD SPECIFICATIONS OR AS APPROVED BY THE ENGINEER. (OMNISEAL 50 OR EQUAL.).


ALL MATERIALS AND CONSTRUCTION SHALL COMPLY WITH CITY REQUIREMENTS. IN THE CASE OF CONFLICTS, THE CITY'S CRITERIA SHALL GOVERN.

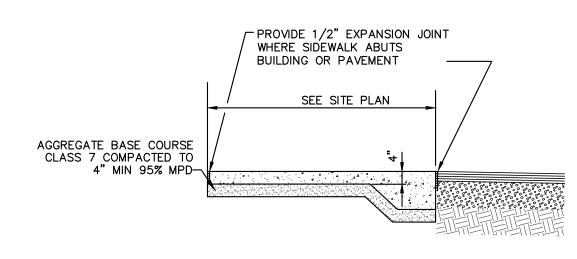

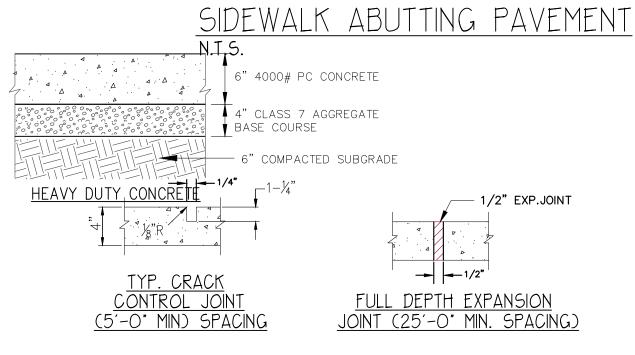

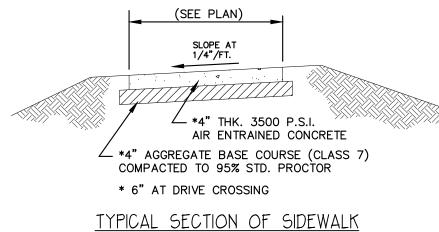



TYP. SIDEWALK SECTION

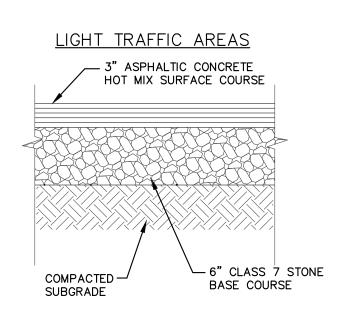


## ASPHALT PAVEMENT SECTION

LIGHT DUTY CONCRETE

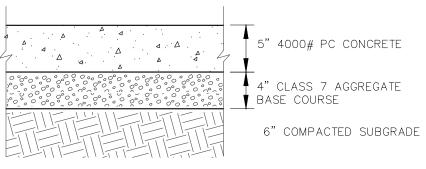


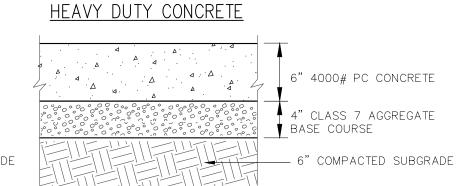


DUMPSTER AREA CONCRETE

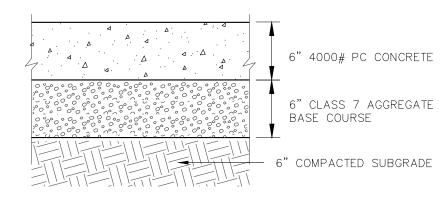

CONCRETE PAVEMENT SECTIONS

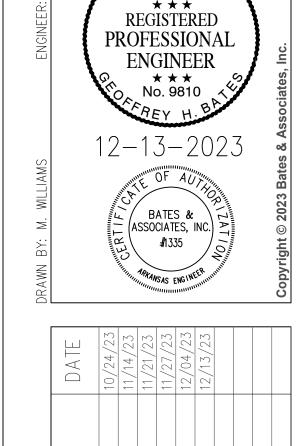

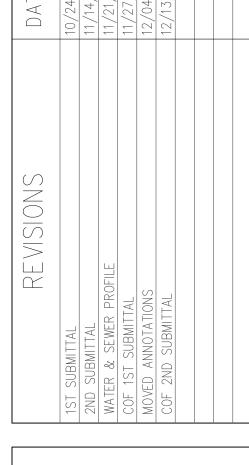



CHURCH OPMENT  $\mathbb{H}$ BRAND SCALE

X Z





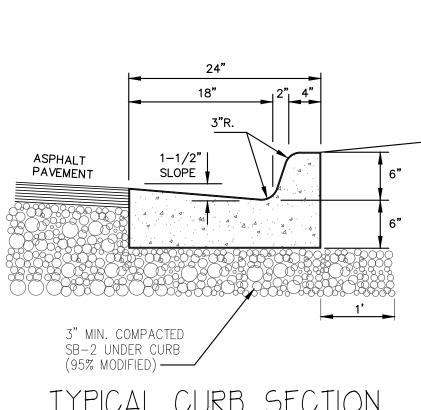

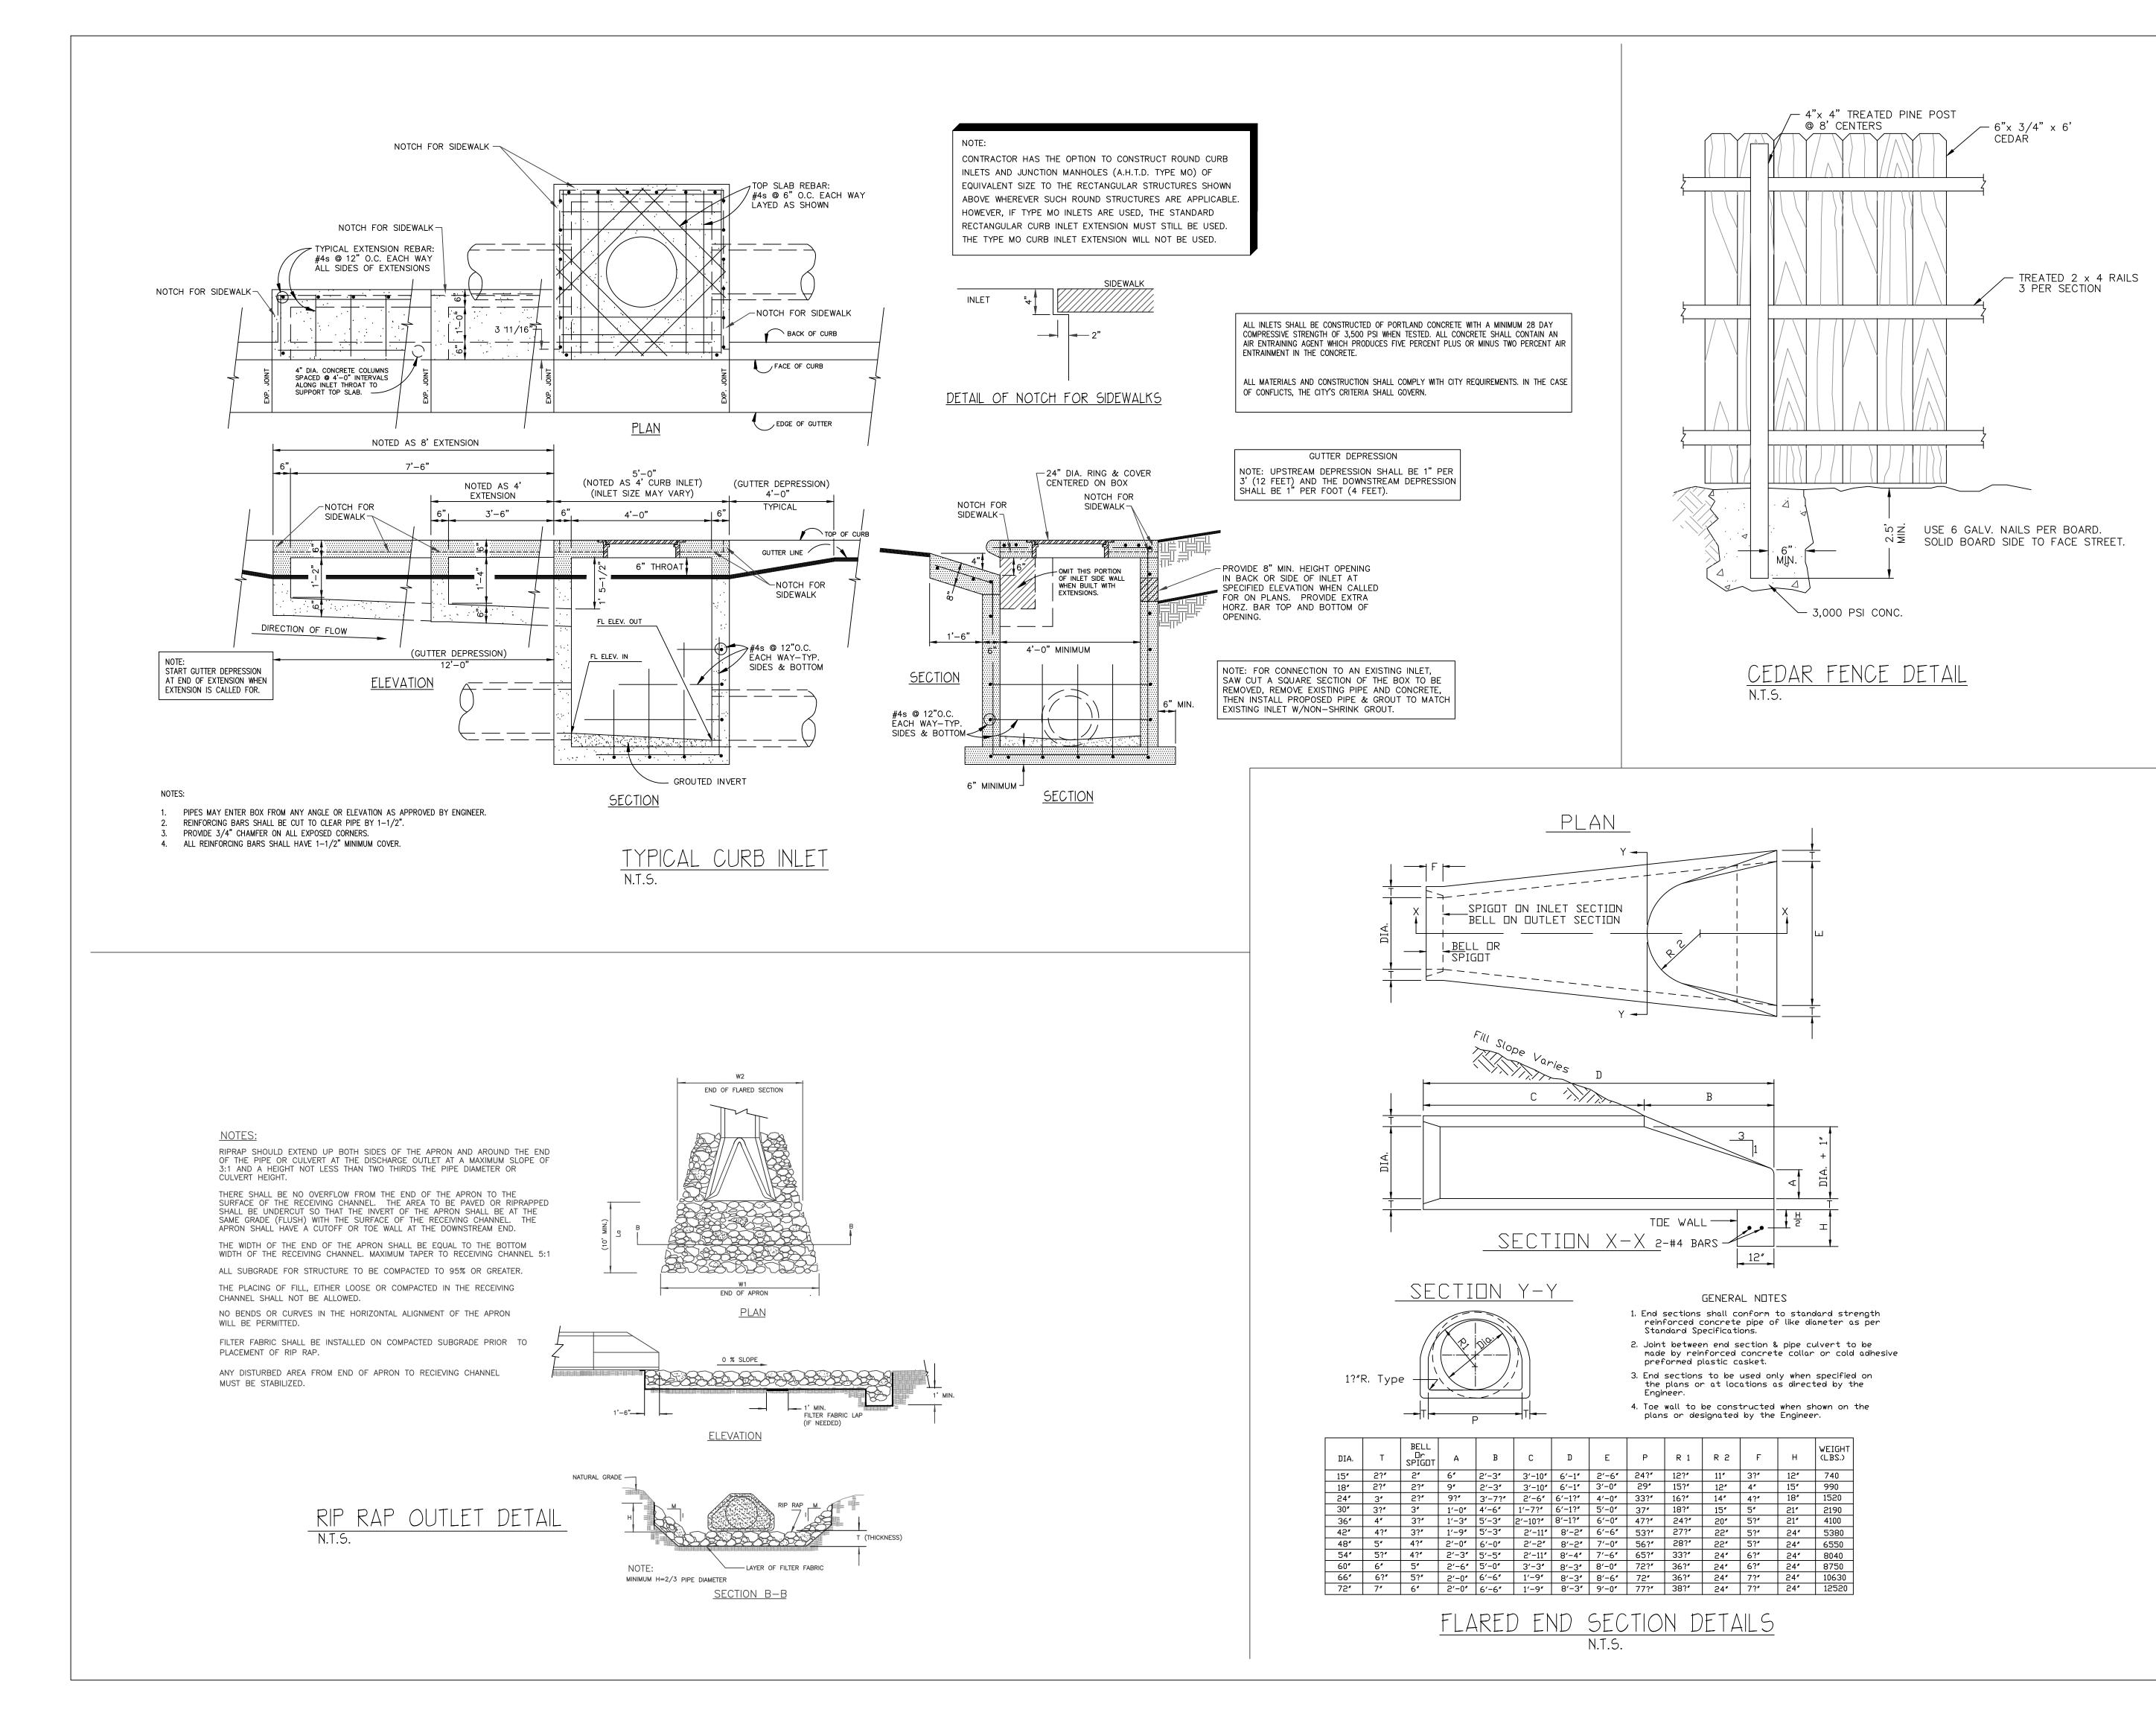

REVISIONS

10/24/23

2ND SUBMITTAL

2ND SUBMITTAL

MATER & SEWER PROFILE

COF 1ST SUBMITTAL

11/21/23

12/04/23

COF 2ND SUBMITTAL

12/13/23

BRAND NEW CHURCH SCALE DEVELOPMENT PLANS DETAILS


ARGE


rs - Surveyors
dge Dr / Fayetteville, AR 72704


Engineers - Surv





DRAWING NO.

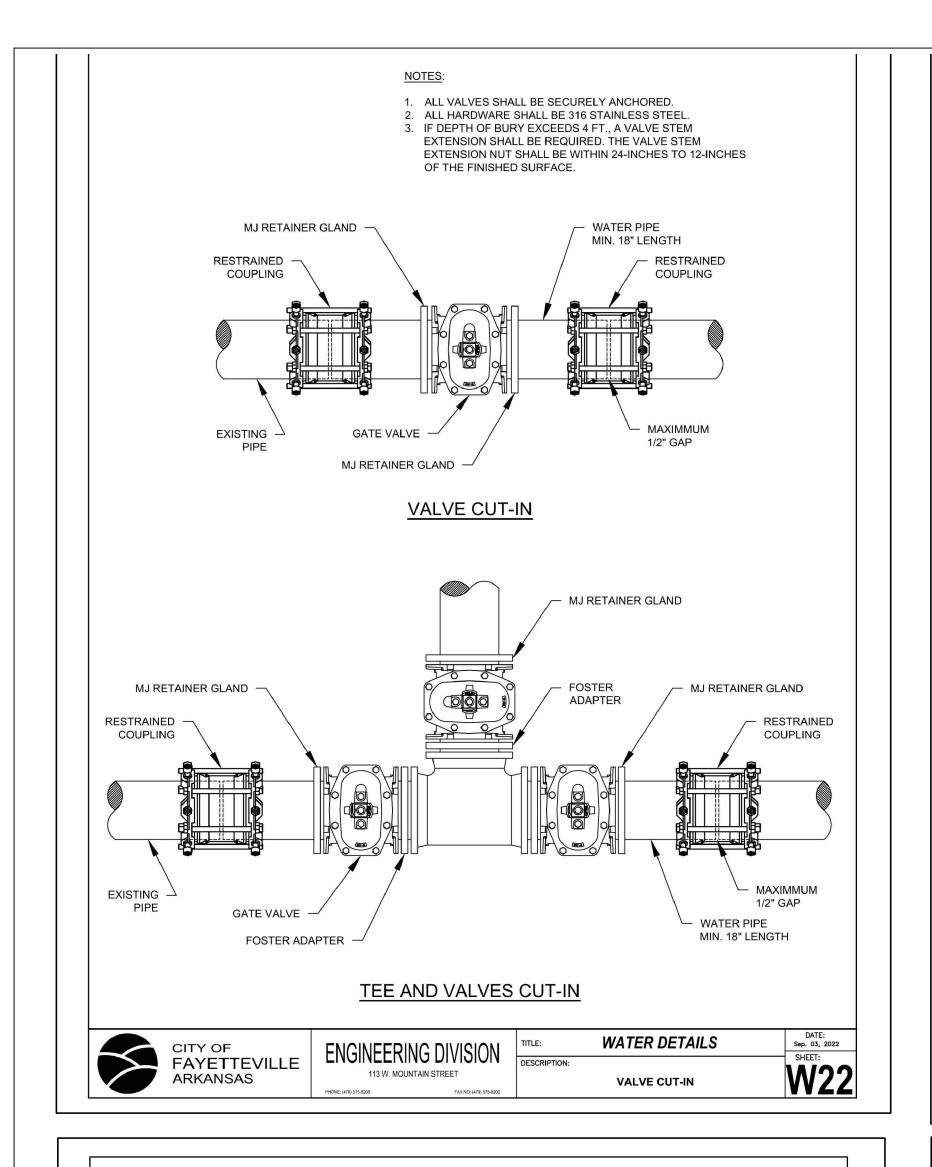


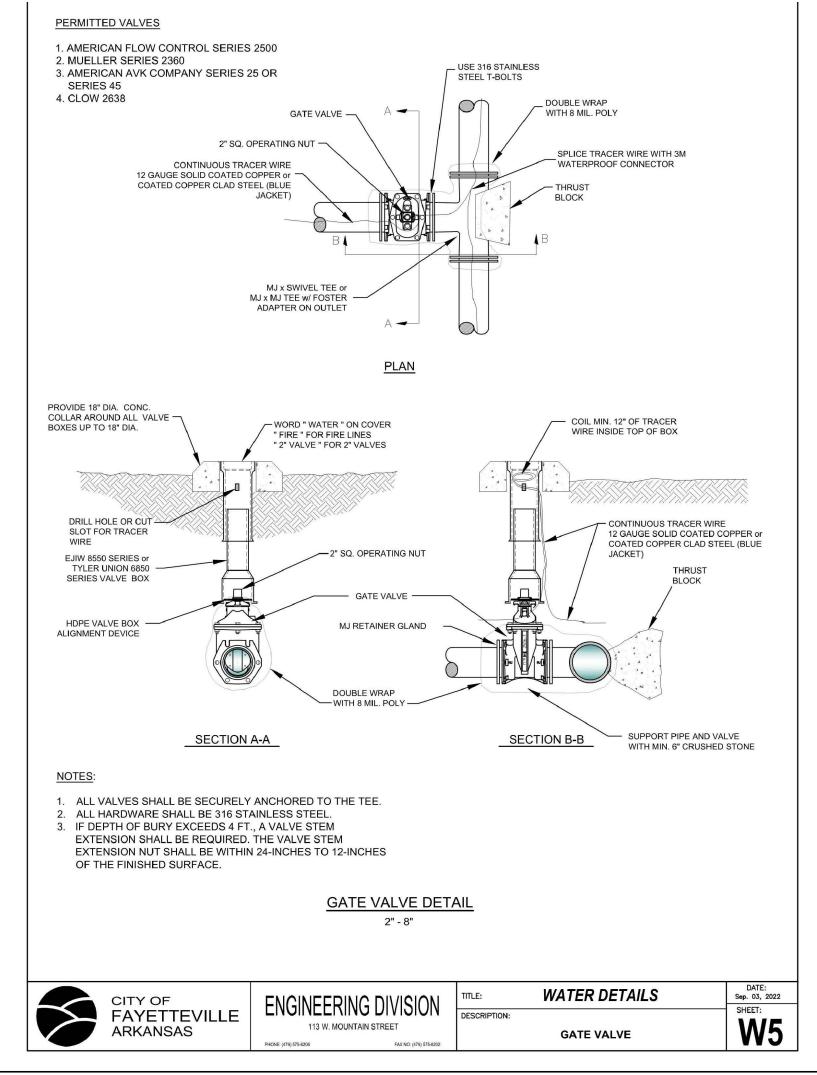

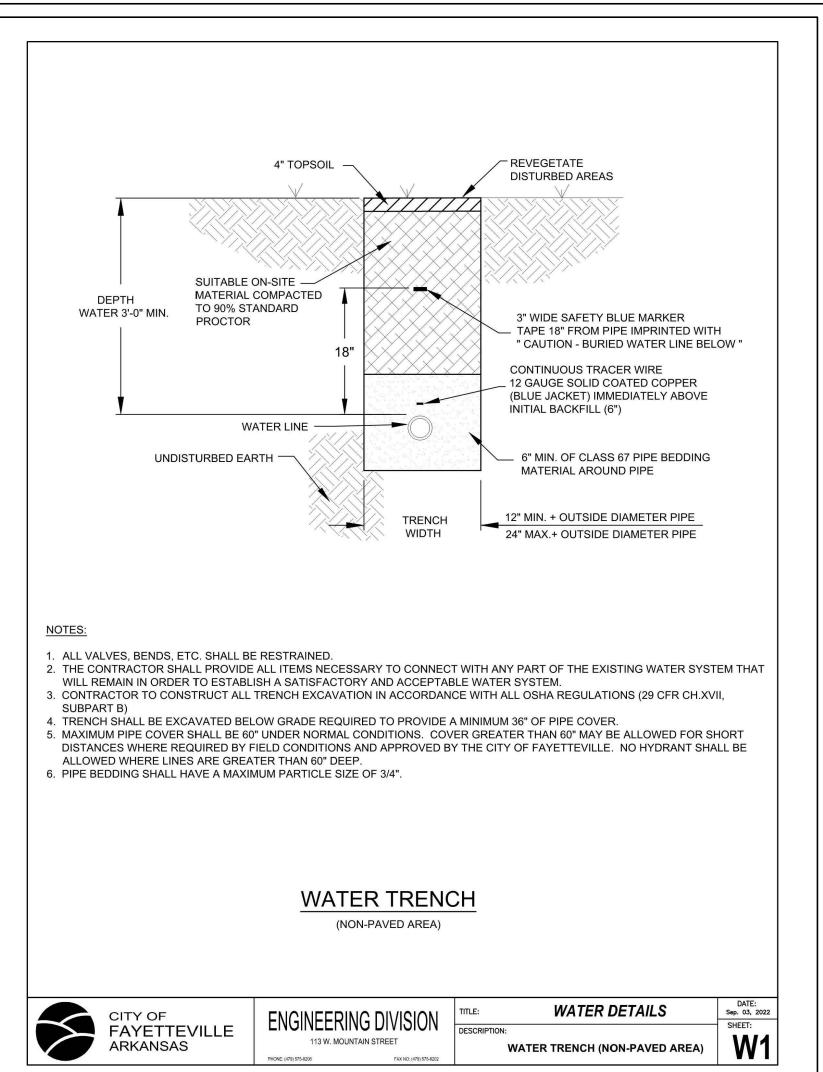

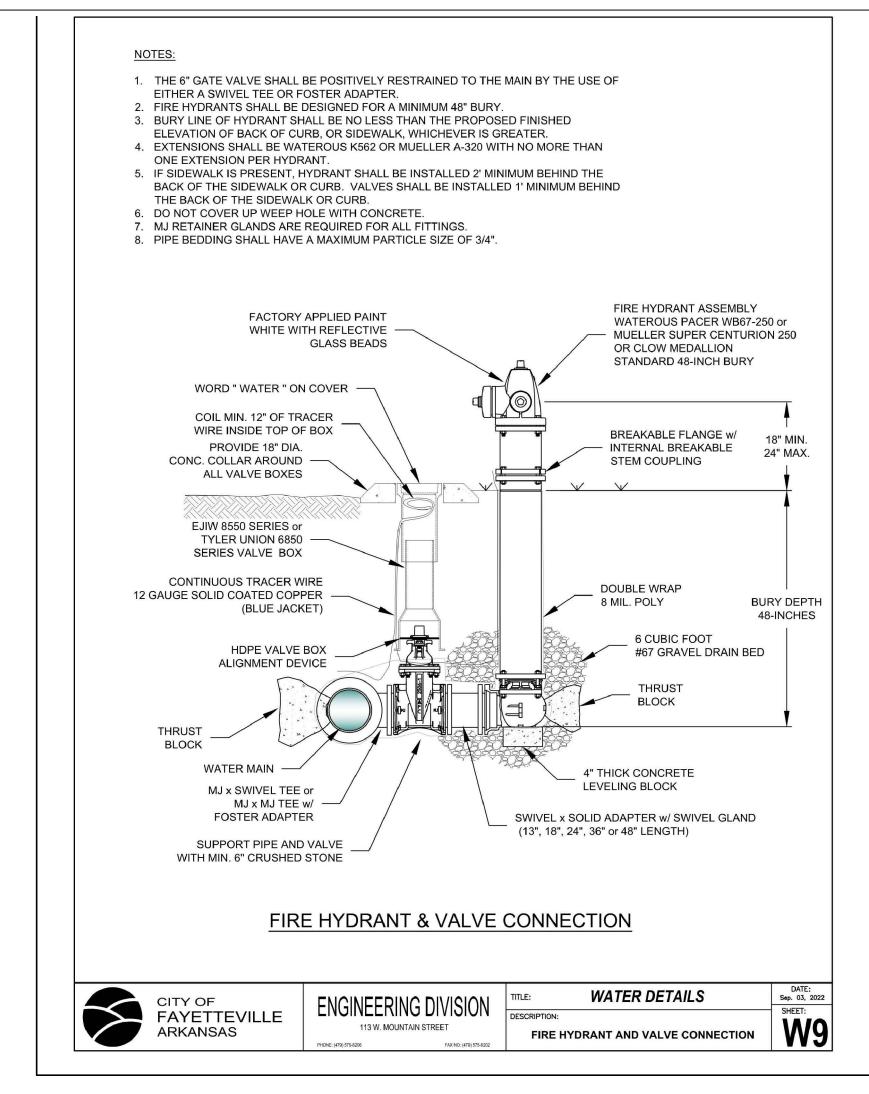

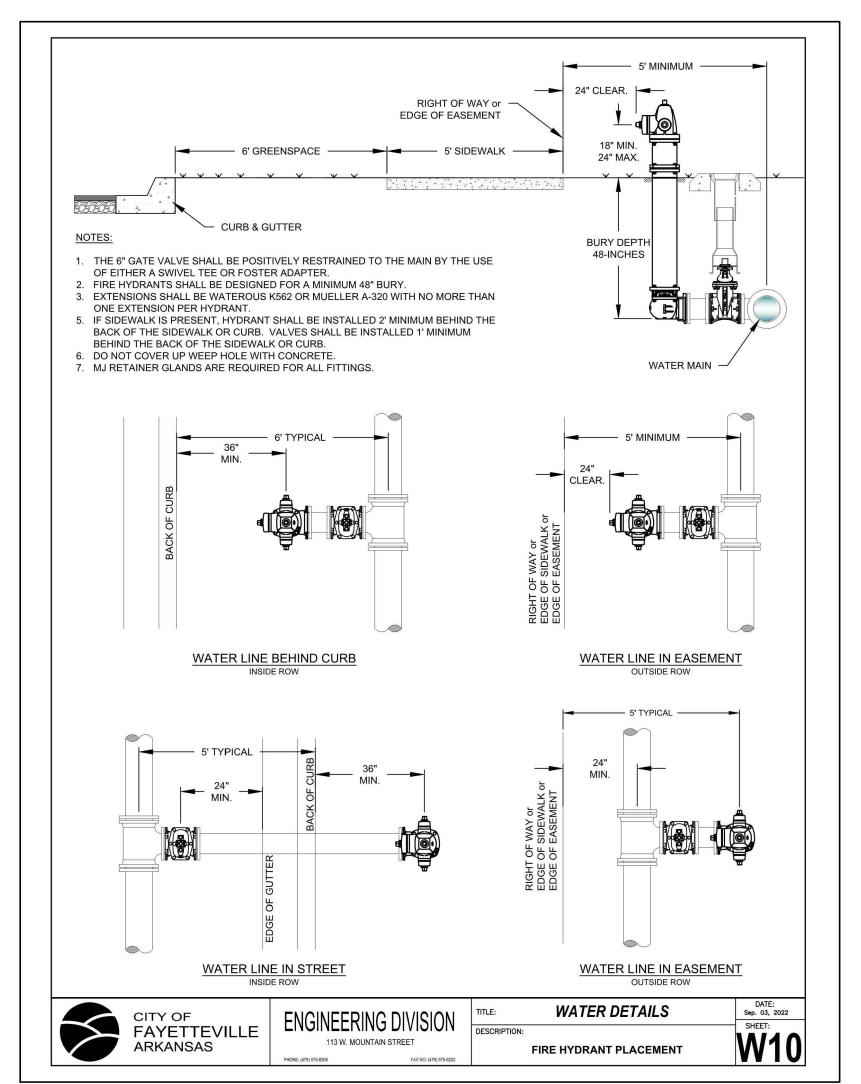

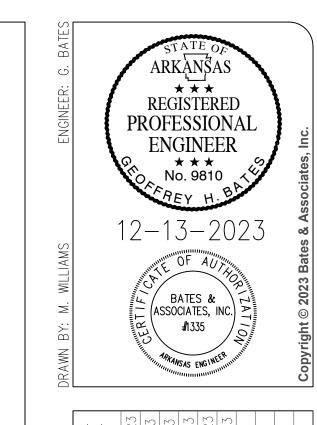



X OPMEN BRAND SCALE ARGE


CHURCH


 $\mathbb{H}$ 


gin

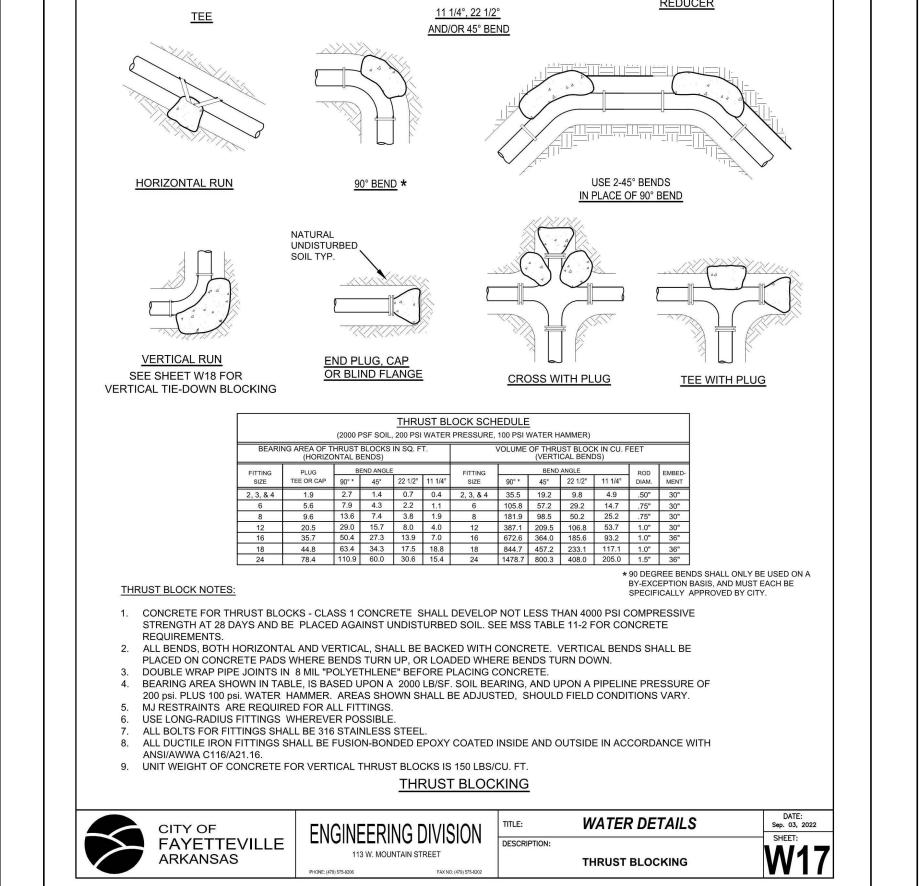


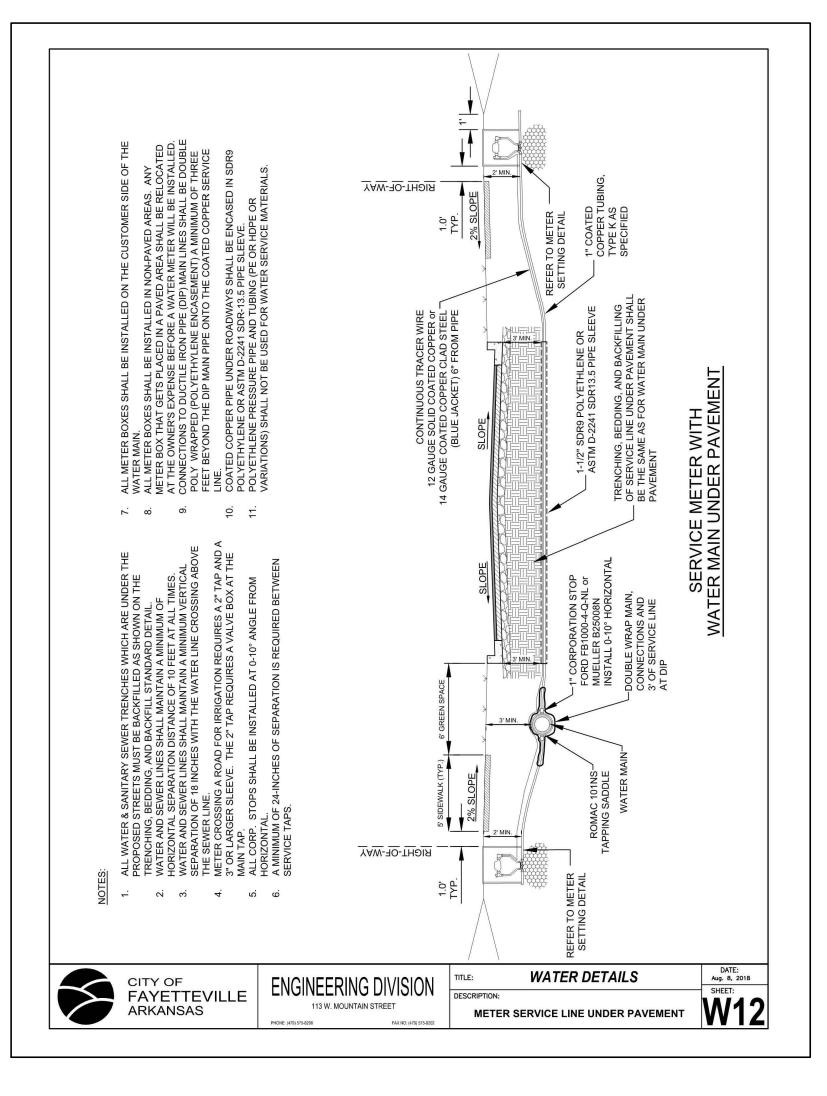


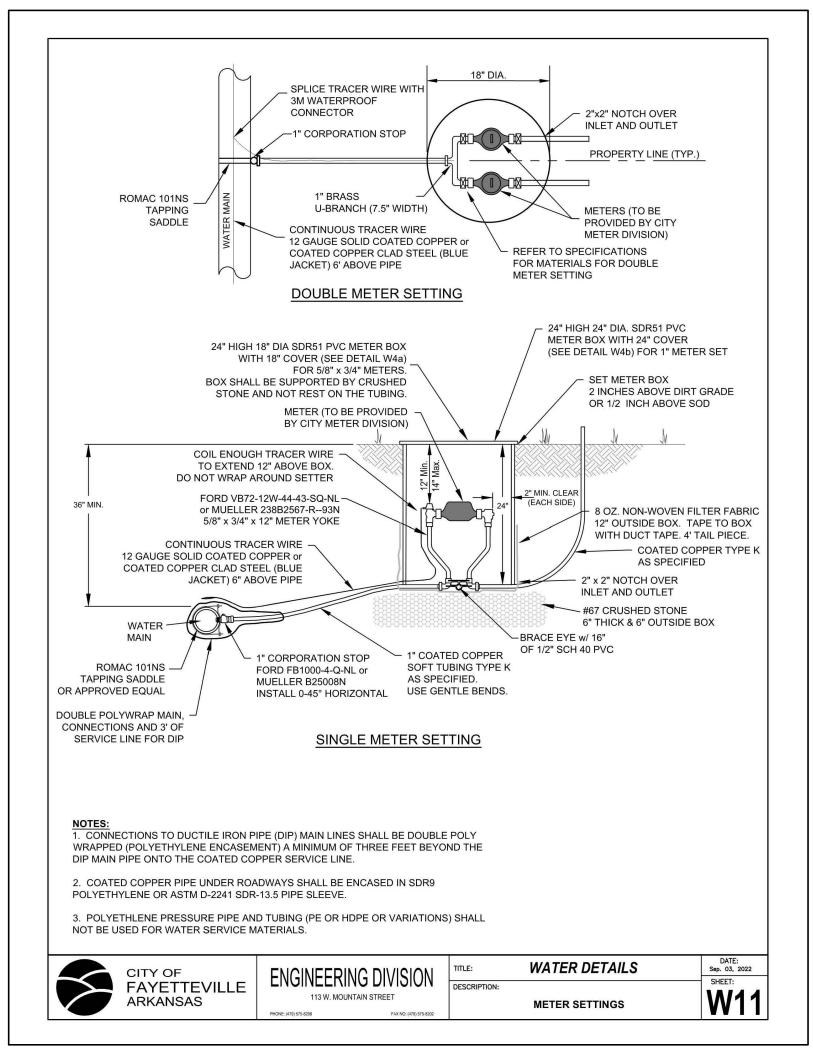


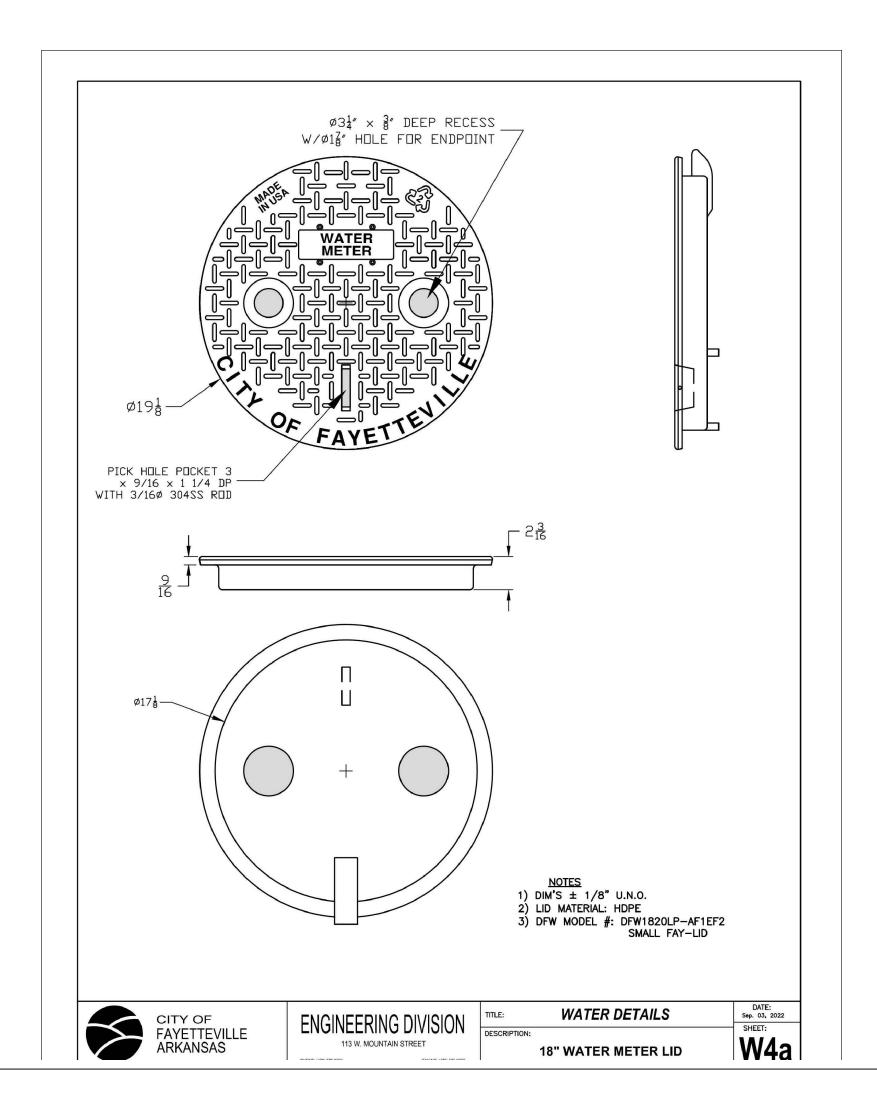

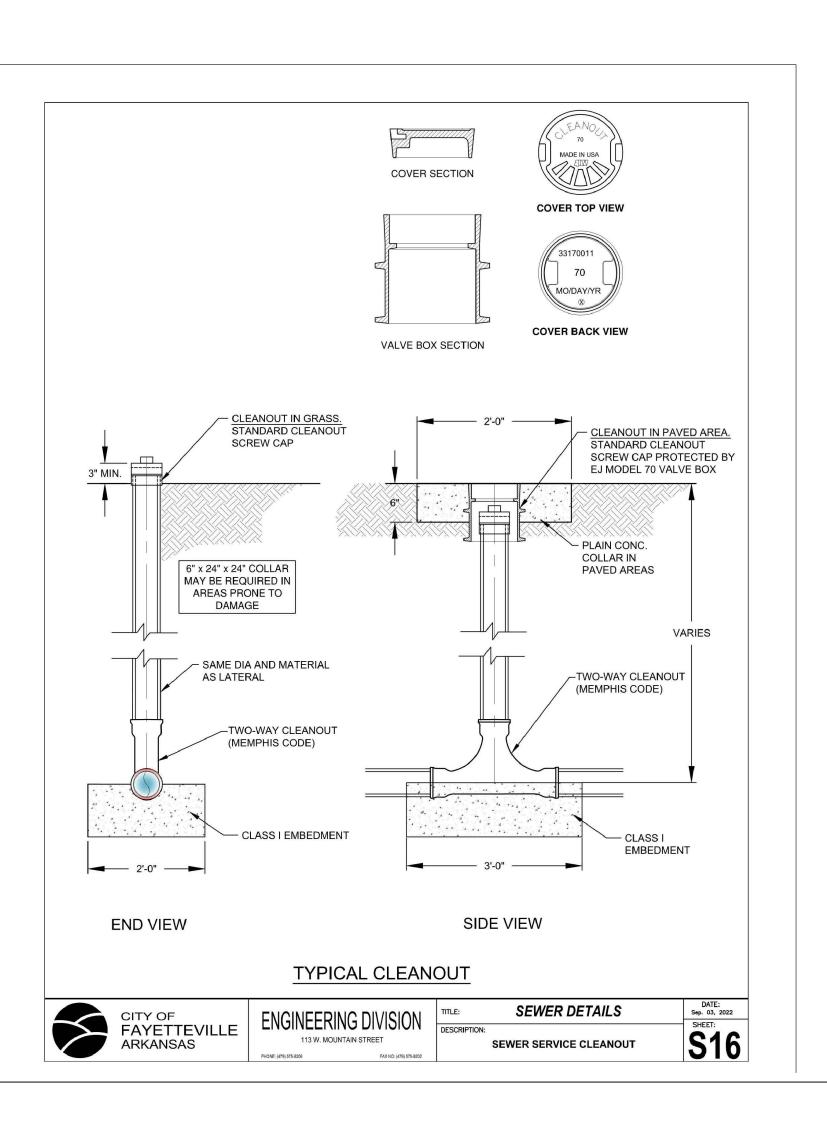

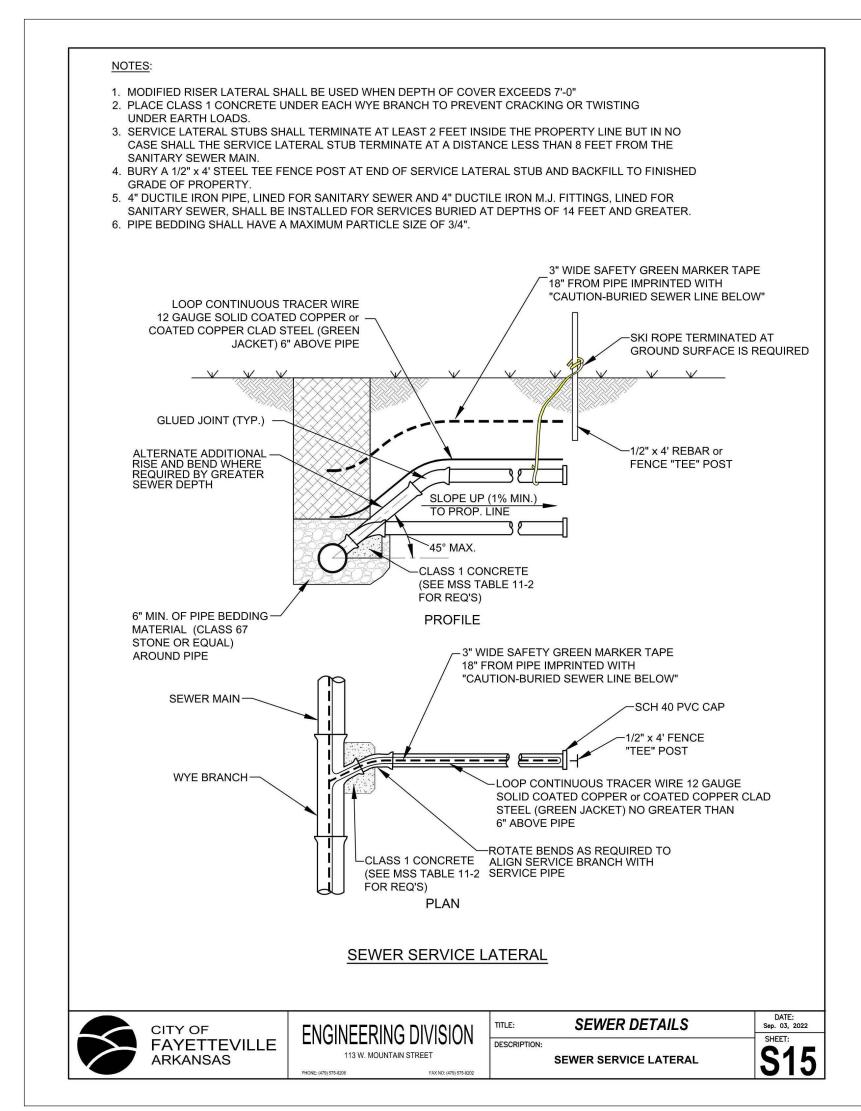

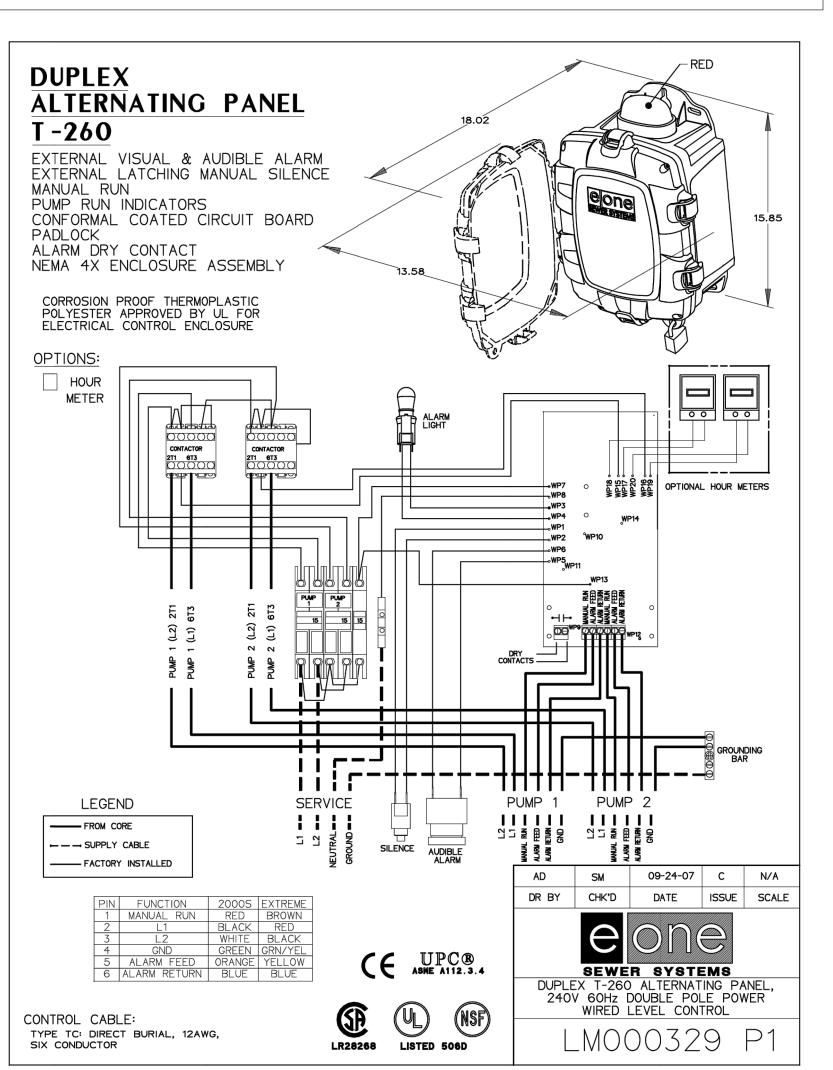

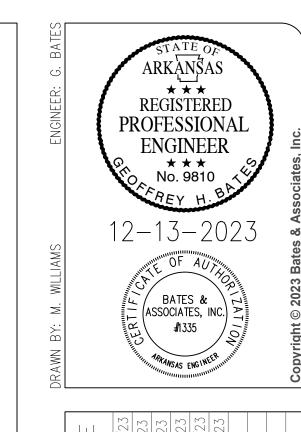

IST SUBMITTAL

2ND SUBMITTAL

WATER & SEWER PROFILE

COF 1ST SUBMITTAL

MOVED ANNOTATIONS

COF 2ND SUBMITTAL


12/13/


BRAND NEW CHURCH LARGE SCALE DEVELOPMENT F


X


Engineers - Surveyors
7230 S Pleasant Ridge Dr / Fayetteville, AR 72704
PH: (479) 442-9350 / batesnwa com




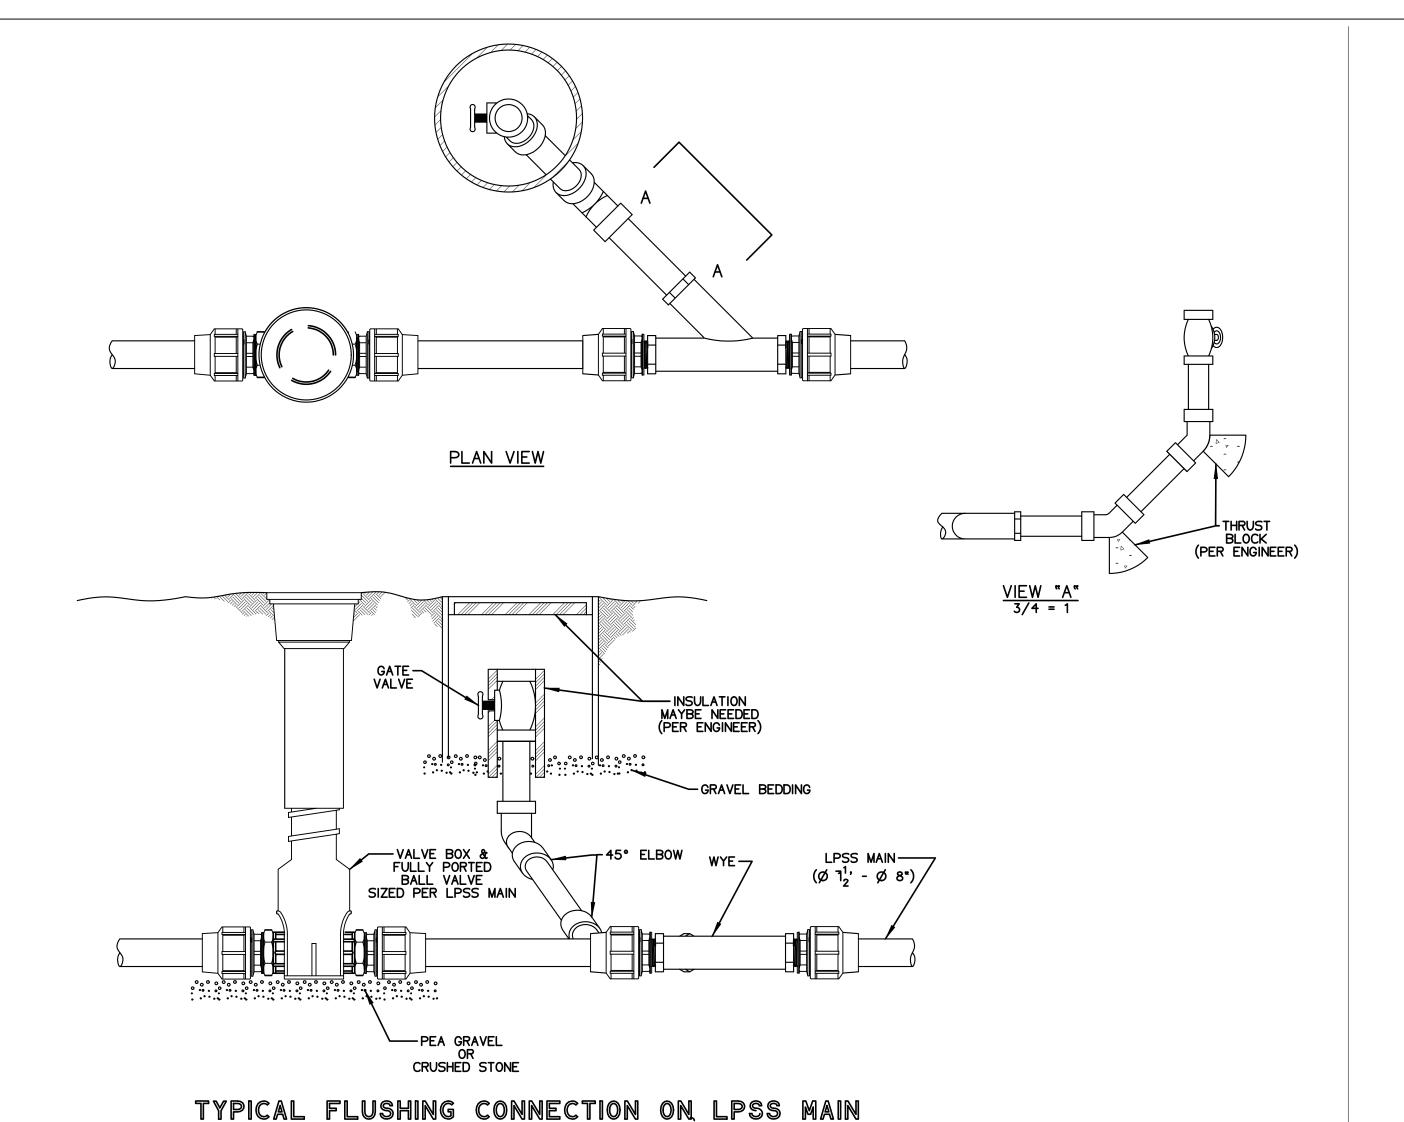

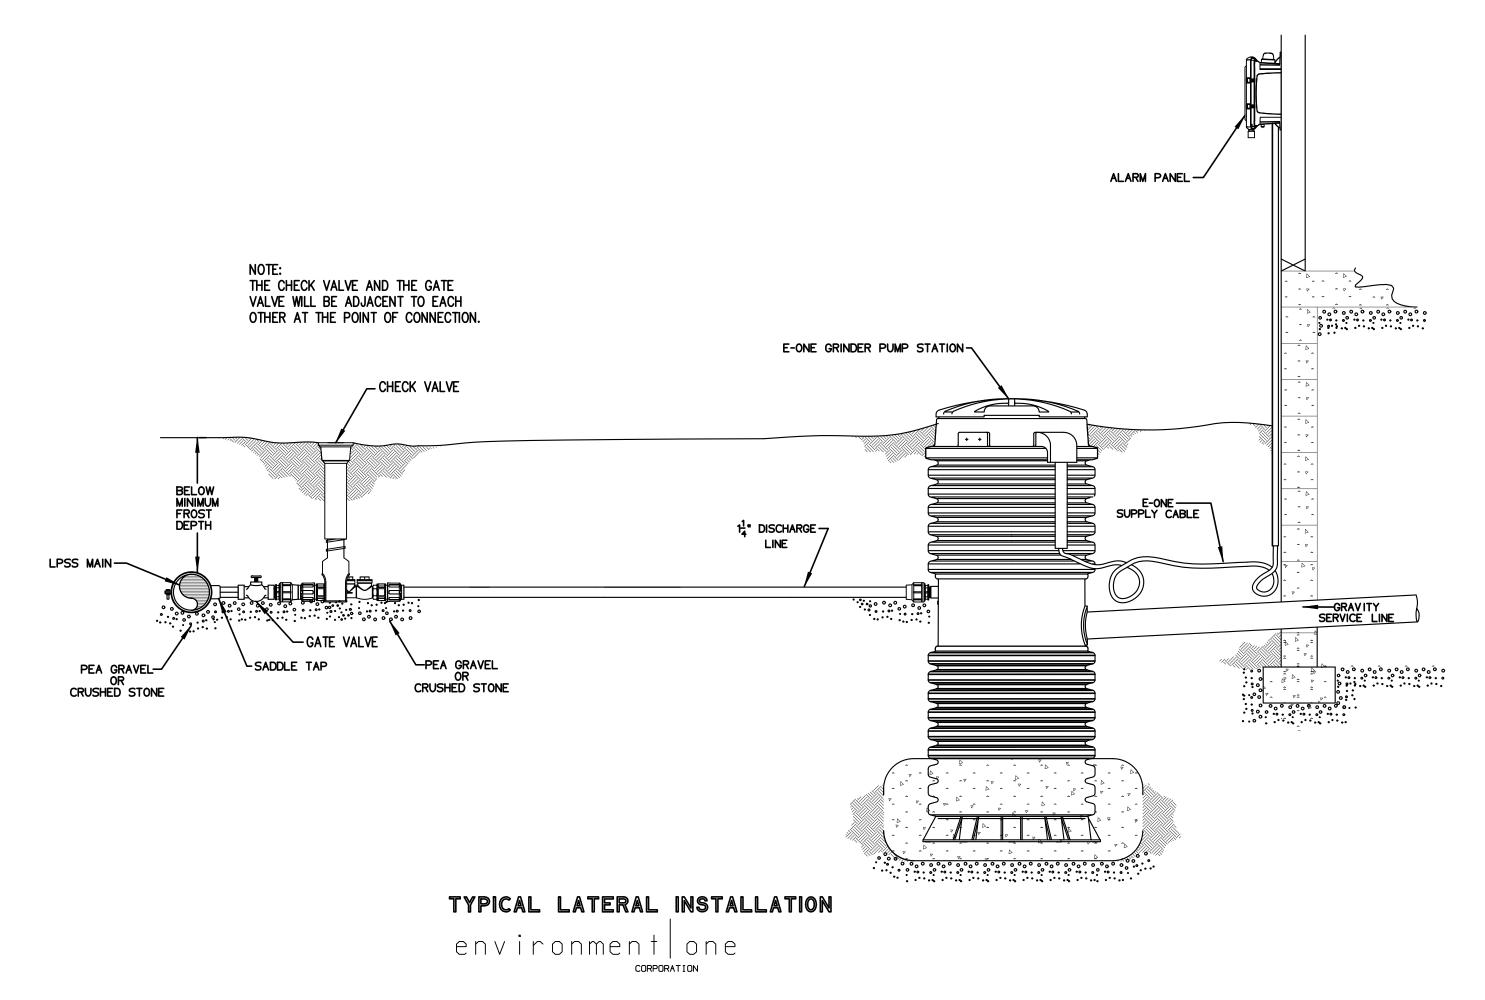

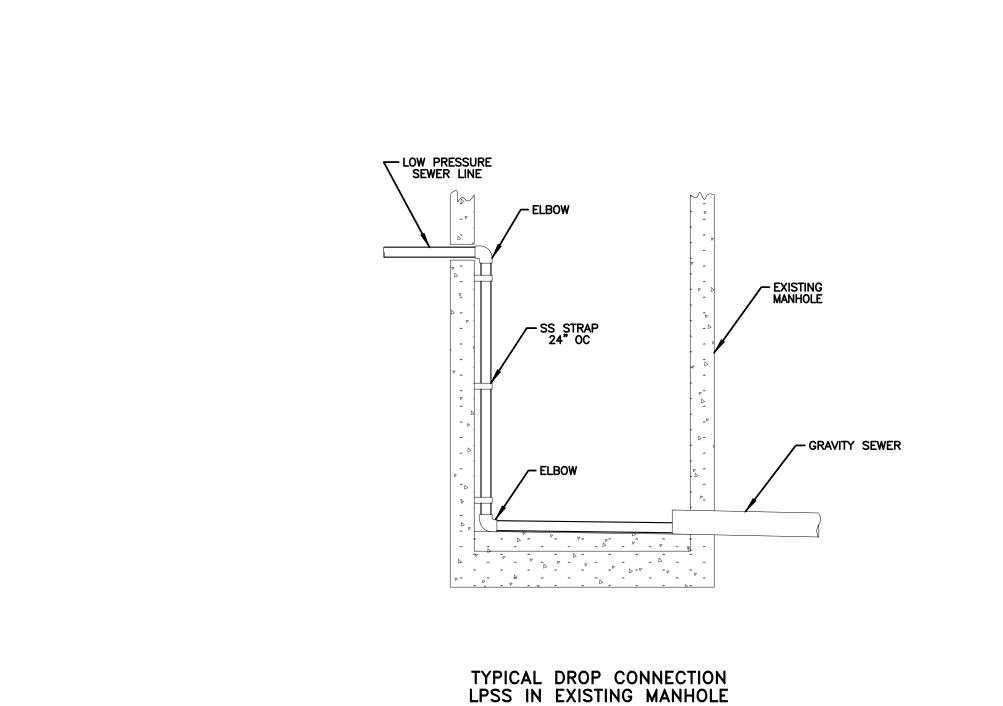

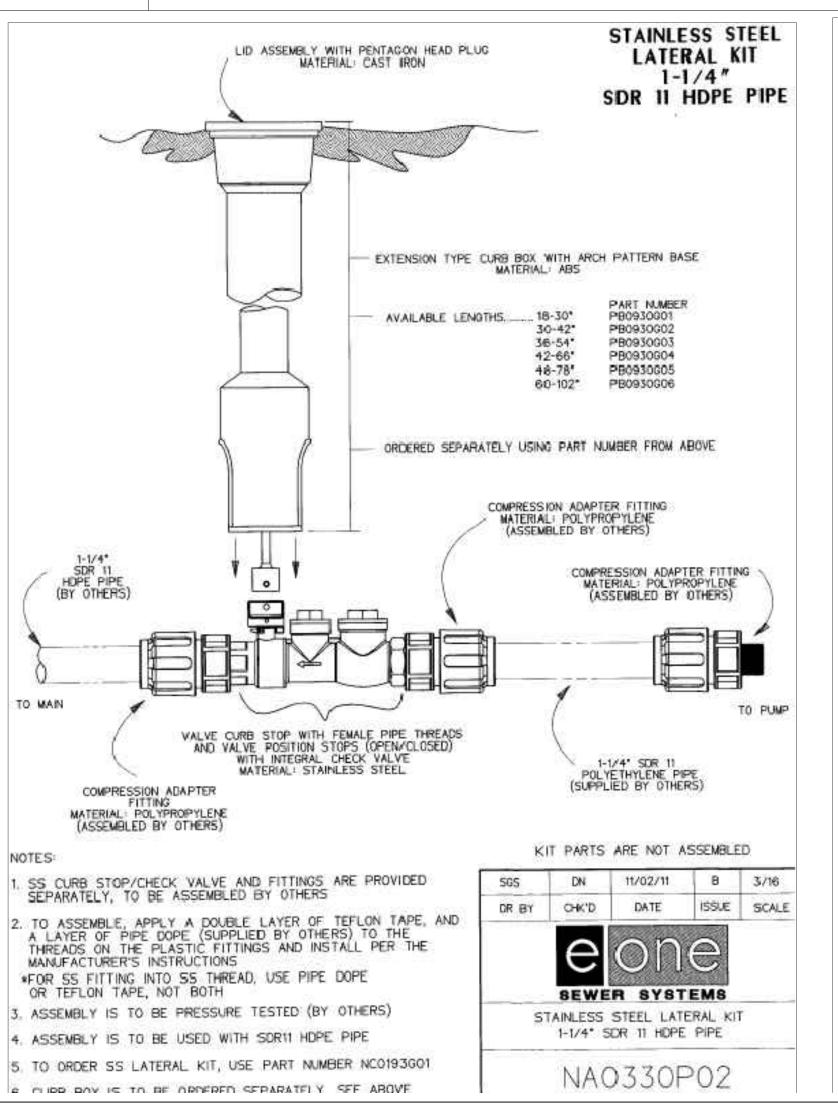

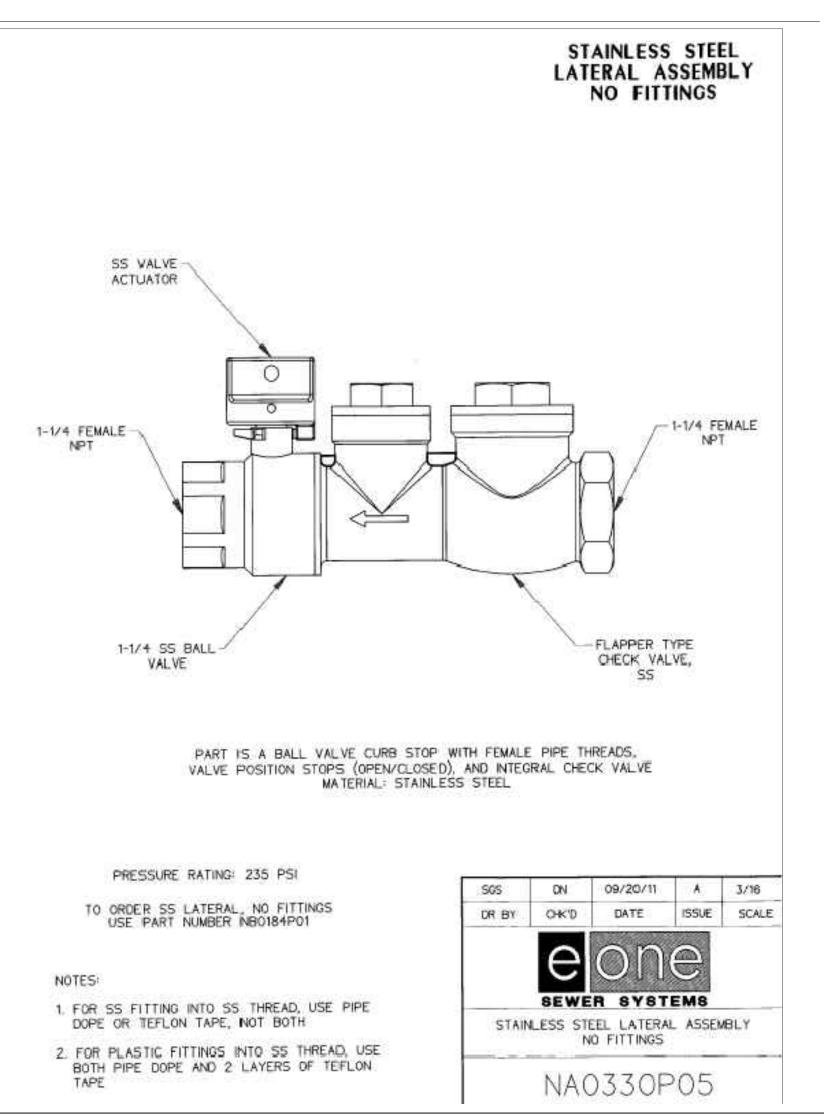



REVISIONS

1ST SUBMITTAL

2ND SUBMITTAL

WATER & SEWER PROFILE

COF 1ST SUBMITTAL

11/21/23


MOVED ANNOTATIONS


COF 2ND SUBMITTAL

12/13/23


BRAND NEW CHURCH
LARGE SCALE DEVELOPMENT PLAN
DETAILS
FARMINGTON, ARKANSAS

Engineers - Surveyors
7230 S Pleasant Ridge Dr / Fayetteville, AR 72704

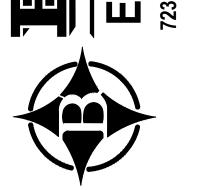

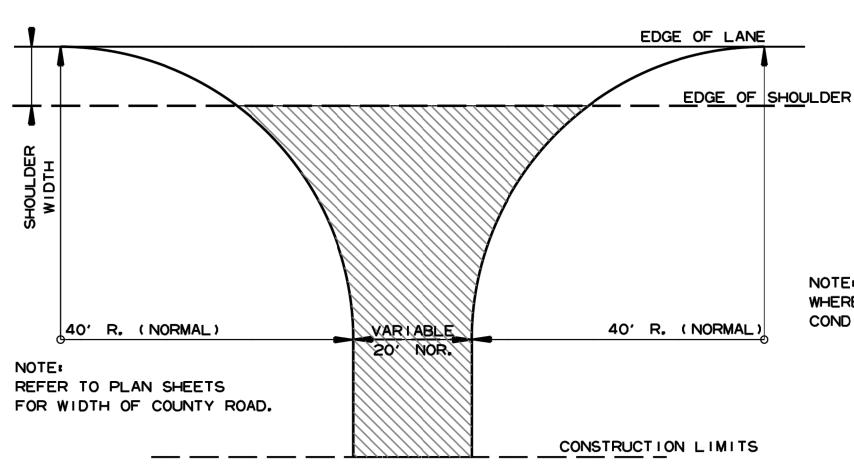

DETAIL FOR COUNTY ROAD TURNOUTS OPEN SHOULDER SECTION

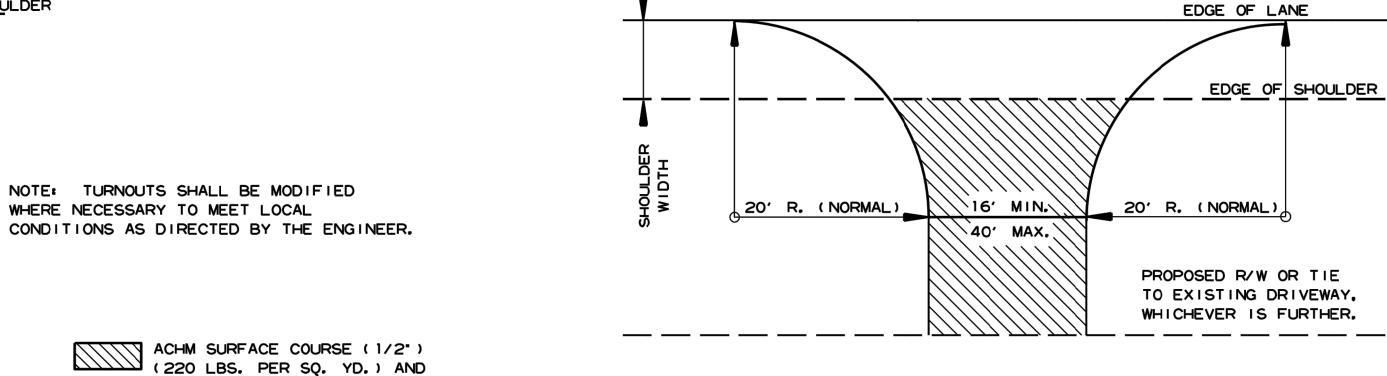

AGGREGATE BASE COURSE (CLASS 7)

SPECIFIED IN PLANS.


7" COMP. DEPTH, UNLESS OTHERWISE

DETAIL FOR DRIVEWAY TURNOUTS
OPEN SHOULDER SECTION

(ARTERIALS)


NOTE: TURNOUTS AND PRIVATE DRIVES
SHALL BE MODIFIED WHERE NECESSARY
TO MEET LOCAL CONDITIONS AS DIRECTED
BY THE ENGINEER.

ACHM SURFACE COURSE (1/2")
(220 LBS. PER SQ. YD.) AND
AGGREGATE BASE COURSE (CLASS 7)
7" COMP. DEPTH IF ASPHALT OR
GRAVEL DRIVE EXISTING; OR 6"
CONCRETE IF CONCRETE DRIVE
EXISTING.

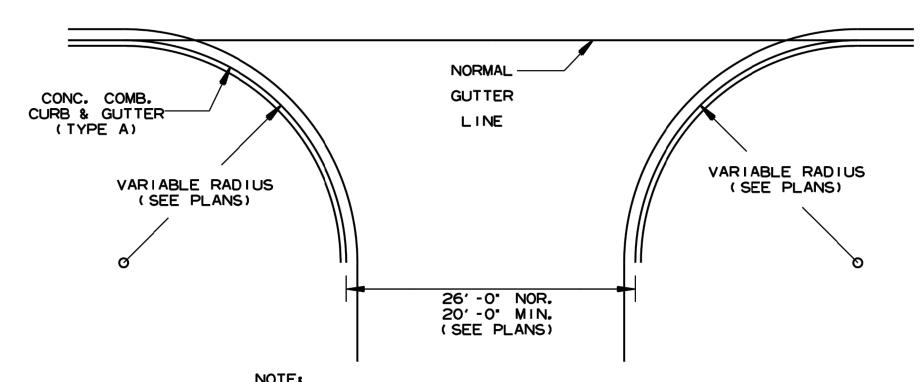

NOTE:
PAVEMENT STRUCTURE FOR STATE HIGHWAYS, CITY STREETS,
& COUNTY ROADS TO BE SAME AS MAIN LANES.


DETAIL OF TURNOUTS, ASPHALT STREETS, COUNTY ROADS & STATE HIGHWAYS CURB & GUTTER SECTION

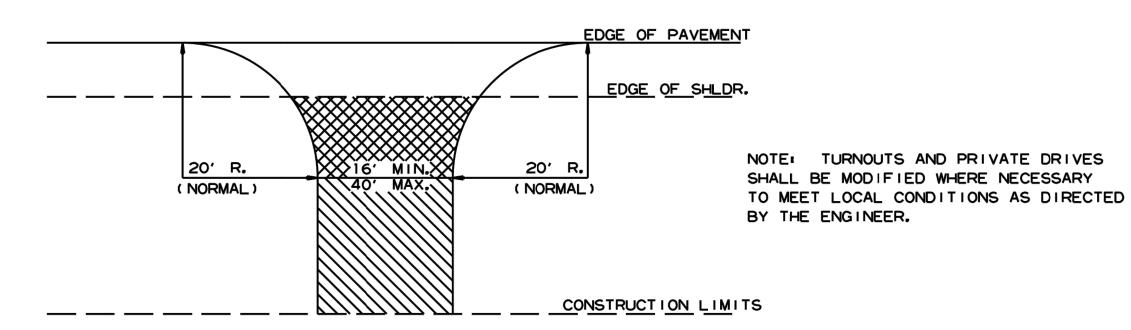

ASPHALT CONCRETE HOT MIX SURFACE
COURSE (220 LBS. PER SQ. YD.)
AGGREGATE BASE COURSE (CLASS 7)
7" COMP. DEPTH IF ASPHALT DRIVE EXIST OR
6" CONCRETE IF CONCRETE DRIVE EXIST.

AGGREGATE BASE COURSE (CLASS 7)
9' COMP. DEPTH OR CONFORM
TO EXISTING DRIVEWAY

DETAIL FOR DRIVEWAY TURNOUTS (COLLECTORS)

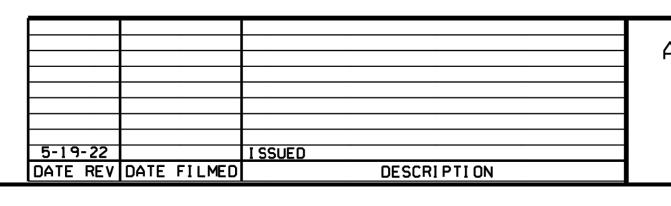

ARKANSAS STATE HIGHWAY COMMISSION

DETAILS OF DRIVEWAYS & STREET

TURNOUTS

STANDARD DRAWING DR-2

DATES & ASSOCIATES, INC. 11/21/23

11/21/23

12/04/23

12/13/23

12/13/23

TEVISIONS

1ST SUBMITTAL

2ND SUBMITTAL

WATER & SEWER PROFILE

COF 1ST SUBMITTAL

MOVED ANNOTATIONS

COF 2ND SUBMITTAL

REGISTERED PROFESSIONAL ENGINEER

© ★ ★ ★ No. 9810

BRAND NEW CHURCH SCALE DEVELOPMENT PLA DETAILS

Engineers - Surveyors
7230 S Pleasant Ridge Dr / Fayetteville, AR 72704
PH: (479) 442-9350 / batesnwa.com

DRAWING NO.